
TOWN OF WINCHESTER ROADWAY IMPROVEMENTS

CHURCH STREET AT WATERFIELD ROAD

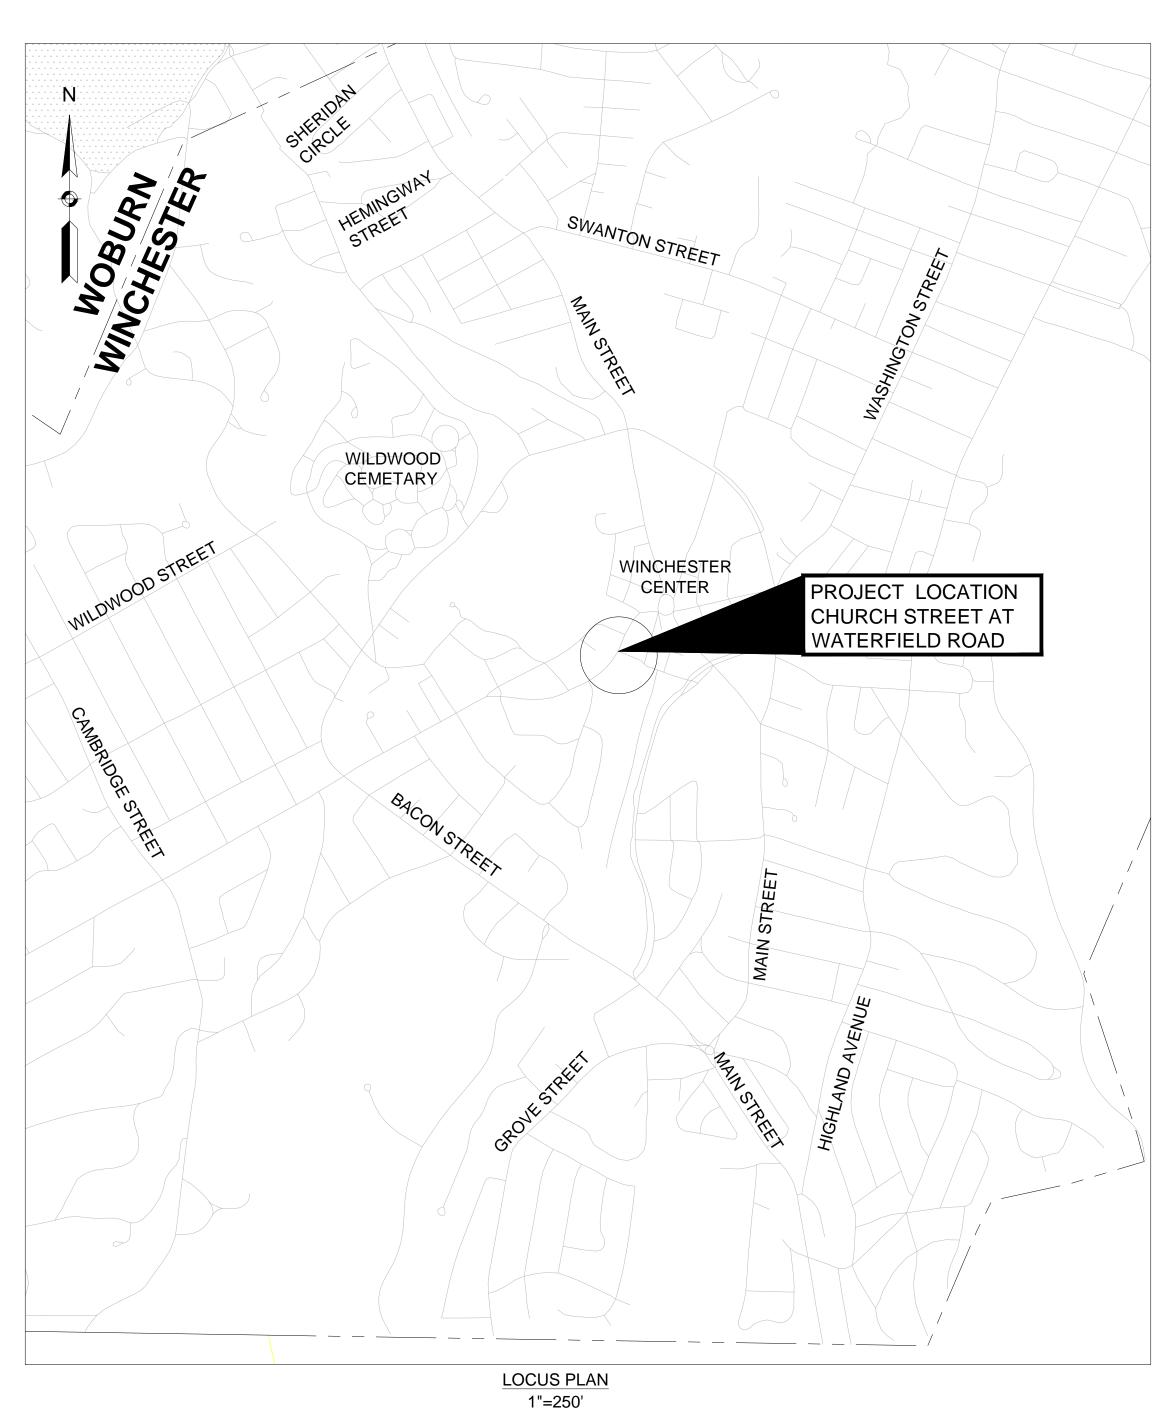

ALL WORK SHALL CONFORM TO THESE PLANS, THE MASSACHUSETTS DEPARTMENT OF TRANSPORTATION (MASSDOT) STANDARD SPECIFICATIONS FOR HIGHWAYS AND BRIDGES DATED 2020, THE MASSDOT 2016 CONSTRUCTION STANDARD DETAILS, THE MASSDOT 1968 STANDARD DRAWINGS FOR TRAFFIC SIGNALS AND HIGHWAY LIGHTING, THE MANUAL ON UNIFORM TRAFFIC CONTROL DEVICES FOR STREETS AND HIGHWAYS, 2009 EDITION, AND ALL INTERIM REVISIONS PUBLISHED BY FEDERAL HIGHWAY ADMINISTRATION.

PROFESSIONAL CERTIFICATION

I HEREBY CERTIFY THAT THESE PLANS
WERE PREPARED OR APPROVED BY
ME, AND THAT I AM A DULY LICENSED
PROFESSIONAL ENGINEER UNDER THE
LAWS OF THE STATE OF [STATE],
LICENSE NO. 49208,
EXPIRATION DATE: 6/30/2022.



SHEET NO. DESCRIPTION

TITLE SHEET & INDEX

CONSTRUCTION PLAN

CURB TIE PLAN

SIGN SUMMARY

PLANTING PLANS

CONSTRUCTION DETAILS

LANDSCAPE DETAILS

LEGEND & ABBREVIATIONS

EXISTING CONDITIONS PLAN

WHEELCHAIR RAMP GRADING PLAN

TRAFFIC SIGN & PAVEMENT MARKING PLAN

TEMPORARY TRAFFIC CONTROL PLANS

G.01

G.02

EX.01

C.01

CT.01

G.01

WCR.01

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SS.01

L.01

TTCP.01-TTCP.03

CD.01-CD.04

CD.05 - CD.06

REUSE OF DOCUMENTS ALL DRAWINGS ARE INSTRUMENTS OF PROFESSIONAL SERVICE FOR THIS PROJECT. REUSE OR ALTERATION IS AT THE USER'S SOLE RISK

 REUSE OR ALTERATION IS AT THE USER'S SOLE RISK.

 DSGN
 KMF

 DR
 CBK


 CHK
 MAB

 APVD
 ELG

 NO.
 DATE

 REVISION
 BY

 APVD

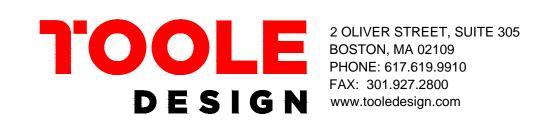

CHURCH STREET AT WATERFIELD ROAD

TITLE SHEET & INDEX

FINAL DESIGN SUBMISSION PROJECT NO. 60169

DATE

AUGUST 2021


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G.01

G.01
SHEET NO.
1 OF 19

KISTING	PROPOSED	DESCRIPTION	TRAFFIC SYME	BOLS		ABBREVI	ATIONS	ABBREVI	ATIONS (cont.)
	(III) CB	CATCH BASIN	EXISTING	PROPOSED	DESCRIPTION	GENERAL		GENERAL	
		CATCH BASIN CURB INLET	<i>0</i> 1	<i>Ø</i> 1	CONTROLLER PHASE ACTUATED	AADT	ANNUAL AVERAGE DAILY TRAFFIC	MH	MANHOLE
		GUTTER INLET	[6]			ABAN A.C.		MHB MIN	MASSACHUSETTS HIGHWAY BOUND MINIMUM
GP GP	G GP	GAS PUMP			TRAFFIC SIGNAL HEAD (SIZE AS NOTED)	A.C. ACCM PIPE	ASPHALT CONCRETE ASPHALT COATED CORRUGATED METAL PIPE		NOT IN CONTRACT
MB	□ MB	MAIL BOX				ADJ	ADJUST	NO.	NUMBER
		POST SQUARE			WIRE LOOP DETECTOR (6' x 6' TYP UNLESS OTHERWISE SPECIFIED)	APPROX.	APPROXIMATE	PC	POINT OF CURVATURE
WELL	○ ⊕ WELL	POST CIRCULAR WELL	77		VIDEO DETECTION CAMERA	ВС	BOTTOM OF CURB	PCC	POINT OF COMPOUND CURVATURE
EHH	□ EHH	ELECTRIC HANDHOLE				BD.	BOUND	P.G.L.	PROFILE GRADE LINE
	0	FENCE GATE POST		H	MICROWAVE DETECTOR	BE	BEGIN ERADICATION	PI	POINT OF INTERSECTION
GG	o GG	GAS GATE			PEDESTRIAN PUSH BUTTON, SIGN (DIRECTIONAL ARROW AS SHOWN) AND SADDLE		BITUMINOUS	POC POT	POINT ON CURVE POINT ON TANGENT
BHL #	◆ BHL #	BORING HOLE	*	*	EMERGENCY PREEMPTION CONFIRMATION STROBE LIGHT	BL BLDG	BASELINE BUILDING	PRC	POINT ON TANGENT POINT OF REVERSE CURVATURE
	→ MW #	MONITORING WELL	<	←	VEHICULAR SIGNAL HEAD	BLDG		PROJ	PROJECT
TP #	■ TP#	TEST PIT				ВО		PROP	PROPOSED
\(\frac{\partial}{2}\)	\\\\\\\\\\\\\\\\\\\\\\\\\\\\\\\\\\\\\\	HYDRANT	≪——	-	VEHICULAR SIGNAL HEAD, OPTICALLY PROGRAMMED	BOS	BOTTOM OF SLOPE	PSB	PLANTABLE SOIL BORROW
☆	*	LIGHT POLE COUNTY BOUND	←—		FLASHING BEACON	BR.	BRIDGE	PT	POINT OF TANGENCY
CO.BD.		GPS POINT			PEDESTRIAN SIGNAL HEAD, (TYPE AS NOTED OR AS SPECIFIED)	СВ	CATCH BASIN	PVC	POINT OF VERTICAL CURVATURE
(C)	(c)	CABLE MANHOLE	⊠ RRSG	⊠ RRSG	RAILROAD SIGNAL	CBCI	CATCH BASIN WITH CURB INLET	PVI PVMT	POINT OF VERTICAL INTERSECTION PAVEMENT
D	<u> </u>	DRAINAGE MANHOLE				CC CCM	OLIVILITY OCHORLIL	PVT	POINT OF VERTICAL TANGENCY
E	E	ELECTRIC MANHOLE	- ├ - OR ○	•	SIGNAL POST AND BASE (ALPHA-NUMERIC DESIGNATION NOTED)	CEM	OLIVILIAT OCIACILIL WIXOCIAIXT	PWW	PAVED WATER WAY
©	G	GAS MANHOLE	0	€ 20'	MAST ARM, SHAFT AND BASE (ARM LENGTH AS NOTED)	CI	CURB INLET or CAST IRON	R	RADIUS OF CURVATURE
M	M	MISC MANHOLE			HIGH MAST POLE OR TOWER	CIP	CAST IRON PIPE	(R)	RECORD INFORMATION
(S)	(s)	SEWER MANHOLE			SIGN AND POST	CIT	CHANGE IN TYPE	RCP	REINFORCED CONCRETE PIPE
(W)	(T)	TELEPHONE MANHOLE WATER MANHOLE				CL	CENTERLINE	R&D RD	REMOVE AND DISPOSE ROAD
W MHB	w MHB	MASSACHUSETTS HIGHWAY BOUND	0 0	\(\)\(\)\(\)	SIGN AND POST (2 POSTS)	CLF	CHAIN LINK FENCE	RDWY	ROADWAY
MON		MONUMENT		₹ 20′	MAST ARM WITH LUMINAIRE	CMP CO.	CORRUGATED METAL PIPE COUNTY	REM	REMOVE
SB		STONE BOUND		=	OPTICAL PRE-EMPTION DETECTOR	CO. CONC	CONCRETE	RET	RETAIN
TB		TOWN OR CITY BOUND			CONTROL CABINET, GROUND MOUNTED	CONT	CONTINUOUS	RET WALL	RETAINING WALL
\triangle		TRAVERSE OR TRIANGULATION STATION		_		CONST	CONSTRUCTION	ROW	RIGHT OF WAY
L or GUY -o	TPL or GUY	TROLLEY POLE OR GUY POLE			CONTROL CABINET, POLE MOUNTED	CPP	CORRUGATED PLASTIC PIPE	R&R	REMOVE AND RESET
HTP	LIED	TRANSMISSION POLE			FLASHING BEACON CONTROL AND METER PEDESTAL	CR GR	CROWN GRADE	RR R&S	RAILROAD REMOVE AND STACK
- UFB	- → UFB	UTILITY POLE W/ FIREBOX			LOAD CENTER ASSEMBLY	CSP	CORRUGATED STEEL PIPE	RT	RIGHT
UPDL - ULT	-∲- UPDL -⊱- ULT	UTILITY POLE WITH DOUBLE LIGHT UTILITY POLE W / 1 LIGHT			PULL BOX 12"x12" (OR AS NOTED)	DHV	DESIGN HOURLY VOLUME	RY	RAILWAY
	->- UPL	UTILITY POLE				DI DIA	DROP INLET DIAMETER	SB	STONE BOUND
	O. L	BUSH			ELECTRIC HANDHOLE 12"x24" (OR AS NOTED)	DIP	DUCTILE IRON PIPE	SHLD	SHOULDER
E & TYPE		TREE		= = = = = = =	= TRAFFIC SIGNAL CONDUIT	DW	STEADY DON'T WALK - PORTLAND ORANGE	SHLO	STATE HIGHWAY LAYOUT LINE
0	Miller	STUMP				DWY	DRIVEWAY	SMH	SEWER MANHOLE
WG	∘ WG	WATER GATE	PAVEMENT MA	APKINICS SVM	ROLS	EE	END ERADICATION	SSD ST	STOPPING SIGHT DISTANCE STREET
PM	· PM	PARKING METER			BOES			STA	STATION
		OVERHEAD CABLE/WIRECURBING	EXISTING	PROPOSED	DESCRIPTION	EMB EOP	EMBANKMENT EDGE OF PAVEMENT	SW	SIDEWALK
		- CONTOURS (ON-THE-GROUND SURVEY DATA)		←	PAVEMENT ARROW - WHITE	EXC	EXCAVATION	T	TANGENT DISTANCE OF CURVE/TRU
99		CONTOURS (PHOTOGRAMMETRIC DATA)	ONII V	™ ANLV	LEGEND "ONLY" - WHITE	EXIST (or EX)		TAN	TANGENT
		UNDERGROUND DRAIN PIPE (DOUBLE LINE 24 INCH AND OVER)	VINLI	VINLT		F&C	EDAME AND COVED	TC TEMP	TOP OF CURB TEMPORARY
		UNDERGROUND ELECTRIC DUCT (DOUBLE LINE 24 INCH AND OVER)		SL	STOP LINE	F&G	FRAME AND GRATE	TOS	TOP OF SLOPE
		UNDERGROUND GAS MAIN (DOUBLE LINE 24 INCH AND OVER)		cw	CROSSWALK	FDN.	FOUNDATION	TYP	TYPICAL
-		UNDERGROUND SEWER MAIN (DOUBLE LINE 24 INCH AND OVER)		 	SOLID WHITE LINE	FG	FINISHED GRADE	UP	UTILITY POLE
		 UNDERGROUND TELEPHONE DUCT (DOUBLE LINE 24 INCH AND OVER) UNDERGROUND WATER MAIN (DOUBLE LINE 24 INCH AND OVER) 		SYL		FLDSTN	FIELDSTONE FLUORESCENT YELLOW- GREEN	VAR	VARIES
		BALANCED STONE WALL			SOLID YELLOW LINE	FYG GAR	CADACE	VC	VERTICAL CURVE
		GUARD RAIL - STEEL POSTS		BWL	BROKEN WHITE LINE	GD	GROUND	VERT	VERTICAL ORANITE OURR
				BYL	BROKEN YELLOW LINE	GG	GAS GATE	VGC WCR	VERTICAL GRANITE CURB WHEEL CHAIR RAMP
		− GUARD RAIL - WOOD POSTS		DWI	DOTTED WHITE LINE	GI	GUTTER INLET	WG	WATER GATE
x	x	- GUARD RAIL - WOOD POSTS - CHAIN LINK OR METAL FENCE		<u>DWL</u>			GALVANIZED IRON PIPE	WIP	WROUGHT IRON PIPE
·		CHAIN LINK OR METAL FENCE WOOD FENCE				GIP			WATER METER/WATER MAIN
· · · · · · · · · · · · · · · · · · ·		CHAIN LINK OR METAL FENCEWOOD FENCETREE LINE		<u>DYL</u>	DOTTED YELLOW LINE	GRAN	GRANITE	WM	
		 CHAIN LINK OR METAL FENCE WOOD FENCE TREE LINE SAWCUT LINE 			DOTTED YELLOW LINE	GRAN GRAV	GRANITE GRAVEL	WM WSO	WATER SHUT OFF VALVE
		CHAIN LINK OR METAL FENCE WOOD FENCE TREE LINE SAWCUT LINE TOP OR BOTTOM OF SLOPE		<u>DYL</u>	DOTTED YELLOW LINE	GRAN GRAV GRD	GRANITE GRAVEL GUARD		
		CHAIN LINK OR METAL FENCE WOOD FENCE TREE LINE SAWCUT LINE TOP OR BOTTOM OF SLOPE EDGE OF PAVEMENT		DYL	DOTTED YELLOW LINE DOTTED WHITE LINE EXTENSION DOTTED YELLOW LINE EXTENSION	GRAN GRAV GRD HDW	GRANITE GRAVEL GUARD HEADWALL	WSO	WATER SHUT OFF VALVE
		CHAIN LINK OR METAL FENCE WOOD FENCE TREE LINE SAWCUT LINE TOP OR BOTTOM OF SLOPE EDGE OF PAVEMENT LIMIT OF MICROMILLING AND OVERLAY		DYL DWLEx DYLEx DBWL	DOTTED YELLOW LINE DOTTED WHITE LINE EXTENSION DOTTED YELLOW LINE EXTENSION DOUBLE WHITE LINE	GRAN GRAV GRD HDW HMA	GRANITE GRAVEL GUARD	WSO	WATER SHUT OFF VALVE
		CHAIN LINK OR METAL FENCE WOOD FENCE TREE LINE SAWCUT LINE TOP OR BOTTOM OF SLOPE EDGE OF PAVEMENT		DYL DYLEX DYLEX	DOTTED YELLOW LINE DOTTED WHITE LINE EXTENSION DOTTED YELLOW LINE EXTENSION	GRAN GRAV GRD HDW	GRANITE GRAVEL GUARD HEADWALL HOT MIX ASPHALT	WSO	WATER SHUT OFF VALVE
		CHAIN LINK OR METAL FENCE WOOD FENCE TREE LINE SAWCUT LINE TOP OR BOTTOM OF SLOPE EDGE OF PAVEMENT LIMIT OF MICROMILLING AND OVERLAY BANK OF RIVER OR STREAM		DYL DWLEx DYLEx DBWL	DOTTED YELLOW LINE DOTTED WHITE LINE EXTENSION DOTTED YELLOW LINE EXTENSION DOUBLE WHITE LINE	GRAN GRAV GRD HDW HMA HOR HYD INV (or I)	GRANITE GRAVEL GUARD HEADWALL HOT MIX ASPHALT HORIZONTAL HYDRANT INVERT	WSO	WATER SHUT OFF VALVE
		CHAIN LINK OR METAL FENCE WOOD FENCE TREE LINE SAWCUT LINE TOP OR BOTTOM OF SLOPE EDGE OF PAVEMENT LIMIT OF MICROMILLING AND OVERLAY BANK OF RIVER OR STREAM BORDER OF WETLAND		DYL DWLEx DYLEx DBWL	DOTTED YELLOW LINE DOTTED WHITE LINE EXTENSION DOTTED YELLOW LINE EXTENSION DOUBLE WHITE LINE	GRAN GRAV GRD HDW HMA HOR HYD	GRANITE GRAVEL GUARD HEADWALL HOT MIX ASPHALT HORIZONTAL HYDRANT INVERT JUNCTION	WSO	WATER SHUT OFF VALVE
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		CHAIN LINK OR METAL FENCE WOOD FENCE TREE LINE SAWCUT LINE TOP OR BOTTOM OF SLOPE EDGE OF PAVEMENT LIMIT OF MICROMILLING AND OVERLAY BANK OF RIVER OR STREAM BORDER OF WETLAND 100 FT WETLAND BUFFER 200 FT RIVERFRONT BUFFER STATE HIGHWAY LAYOUT TOWN OR CITY LAYOUT		DYL DWLEx DYLEx DBWL	DOTTED YELLOW LINE DOTTED WHITE LINE EXTENSION DOTTED YELLOW LINE EXTENSION DOUBLE WHITE LINE	GRAN GRAV GRD HDW HMA HOR HYD INV (or I) JCT L LB	GRANITE GRAVEL GUARD HEADWALL HOT MIX ASPHALT HORIZONTAL HYDRANT INVERT JUNCTION LENGTH OF CURVE LEACH BASIN	WSO	WATER SHUT OFF VALVE
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ONAL CERTIF CERTIFY THAT THES EPARED OR APPROV	FICATION	CHAIN LINK OR METAL FENCE WOOD FENCE TREE LINE SAWCUT LINE TOP OR BOTTOM OF SLOPE EDGE OF PAVEMENT LIMIT OF MICROMILLING AND OVERLAY BANK OF RIVER OR STREAM BORDER OF WETLAND 100 FT WETLAND BUFFER 200 FT RIVERFRONT BUFFER STATE HIGHWAY LAYOUT TOWN OR CITY LAYOUT COUNTY LAYOUT TOWN OR CITY BOUNDARY LINE PROPERTY LINE OR APPROXIMATE PROPERTY LINE EASEMENT REUSE OF DOCUM ALL DRAWINGS ARE INSTRUMENTS OF PROFESSIO REUSE OR ALTERATION IS AT THE L	MENTS NAL SERVICE FOR THIS PROJECT	DYL DWLEX DYLEX DBWL DBYL	DOTTED YELLOW LINE EXTENSION DOTTED YELLOW LINE EXTENSION DOUBLE WHITE LINE DOUBLE YELLOW LINE 2 OLIVER STREET, SUITE 305 BOSTON, MA 02109 PHONE: 617.619.9910 CHUR WATE	GRAN GRAV GRD HDW HMA HOR HYD INV (or I) JCT L LB LP LT MAX MB	GRANITE GRAVEL GUARD HEADWALL HOT MIX ASPHALT HORIZONTAL HYDRANT INVERT JUNCTION LENGTH OF CURVE LEACH BASIN LIGHT POLE LEFT MAXIMUM MAILBOX	WSO X-SECT	FINAL DESIGN SUBM PROJECT NO. DATE
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FINAL DESIGN SUBMISSION

PROFESSIONAL CERTIFICATION

I HEREBY CERTIFY THAT THESE PLANS
WERE PREPARED OR APPROVED BY
ME, AND THAT I AM A DULY LICENSED
PROFESSIONAL ENGINEER UNDER THE
LAWS OF THE COMMONWEALTH OF MASSACHUSETTS,
LICENSE NO. 49208,
EXPIRATION DATE: 6/30/2022.

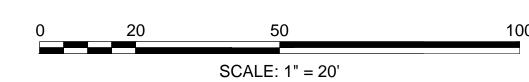

					REUSE OF DOCUMENTS		
1		ALL I	DRAWI		INSTRUMENTS OF PROFESSIONAL SERVICE FOR THIS PROJECT. SE OR ALTERATION IS AT THE USER'S SOLE RISK.		
	DSGN	KMF					
	DR	CBK					
	СНК	MAB					
	APVD	ELG	NO.	DATE	REVISION	BY	APVD

2 OLIVER STREET, SUITE 305
BOSTON, MA 02109
PHONE: 617.619.9910
FAX: 301.927.2800
www.tooledesign.com

CHURCH STREET AT WATERFIELD ROAD

EXISTING CONDITIONS PLAN

PROJECT NO.
60169


DATE
AUGUST 2021

DRAWING NO.
EX.01

SHEET NO.
3 OF 19


GENERAL NOTES:

- 1. THIS PLAN IS BASED UPON AN ON-THE-GROUND SURVEY PERFORMED BY BSC GROUP, INC. IN SEPTEMBER, 2019.
- 2. HORIZONTAL DATUM IS THE NORTH AMERICAN DATUM OF 1983 (NAD 83) AS DERIVED FROM GPS SURVEY PERFORMED BY BSC GROUP. INC.
- 3. VERTICAL DATUM IS THE NORTH AMERICAN VERTICAL DATUM OF 1988 (NAVD 88) AS DERIVED FROM GPS SURVEY PERFORMED BY BSC GROUP. INC.

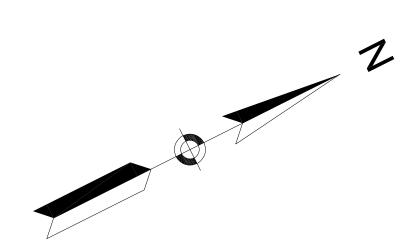

UTILITY NOTE:

1. EXISTING UTILITIES, WHERE SHOWN HEREON, ARE APPROXIMATE. THE CONTRACTOR SHALL BE RESPONSIBLE FOR PROPERLY LOCATING AND COORDINATING ANY ON-SITE ACTIVITY WITH WINCHESTER DEPARTMENT OF PUBLIC WORKS AND THE APPROPRIATE UTILITY COMPANY AND MAINTAINING EXISTING UTILITY SYSTEM SERVICE. THE CONTRACTOR SHALL VERIFY SIZE, LOCATION AND INVERTS OR UTILITIES AND STRUCTURES AS REQUIRED PRIOR TO THE START OF CONSTRUCTION.

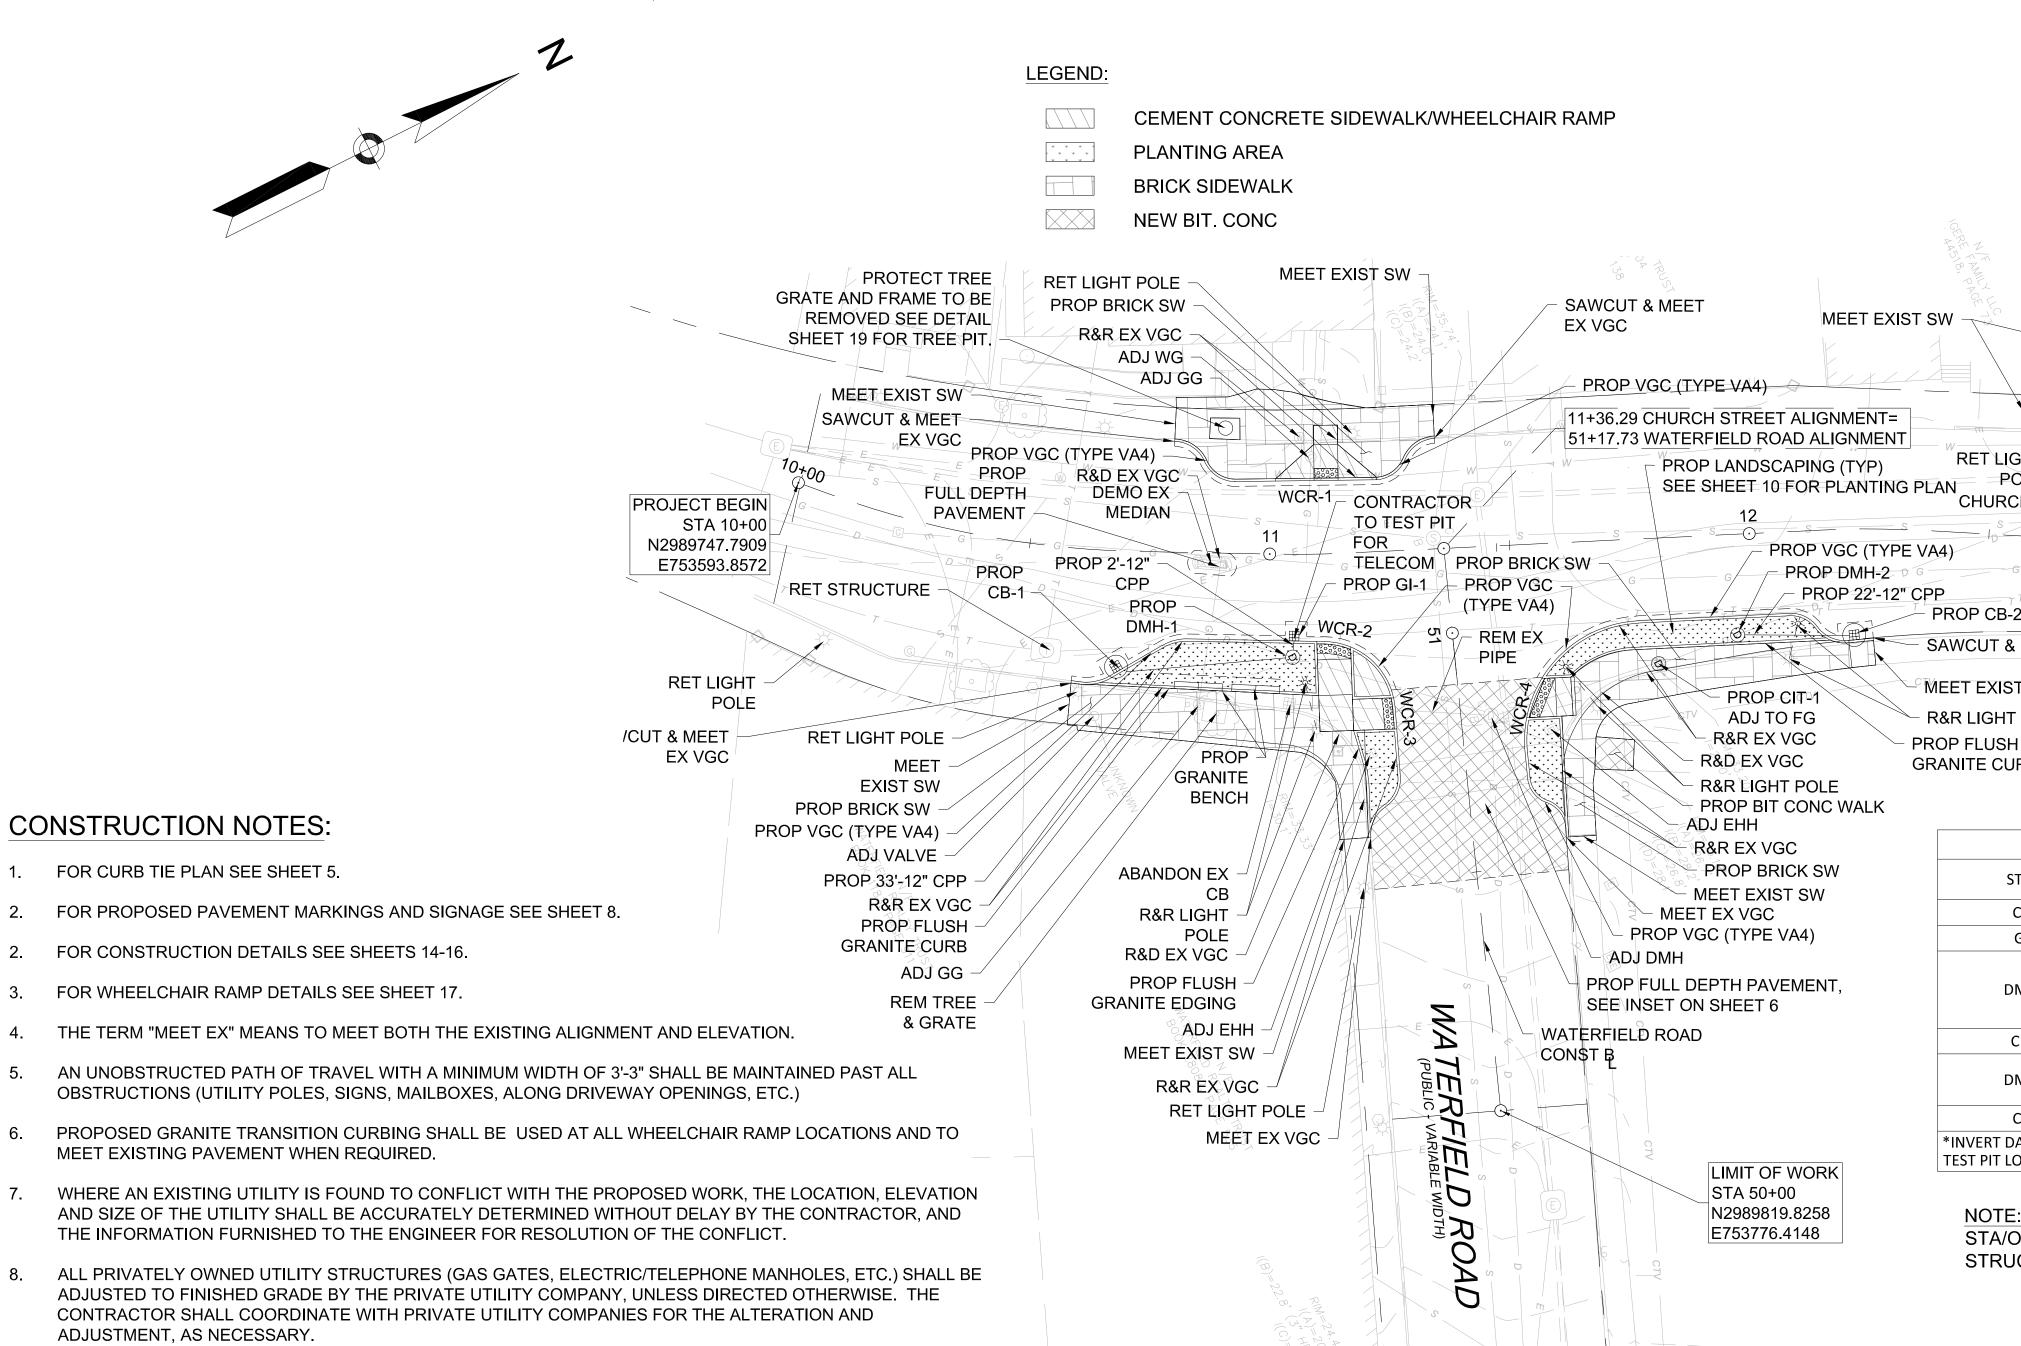

SCALE: 1" = 20'

STR ID	ALIGNMENT	STA & OFFSET	RIM	CONNECTING STR	INV DATA
CB-1	CHURCH STREET	10+69.36 24.99' RT	34.53	DMH-1	*
GI-1	CHURCH STREET	11+05.14 18.03' RT	34.39	DMH-1	31.89 OUT
				EX DRAIN PIPE	*
DMH-1	CHURCH STREET	11+04.92 21.41' RT	34.75	GI-1	*
				CB-1	*
CIT-1	CHURCH STREET	11+79.85 26.17' RT	33.75	EX DMH	29.00 OUT
DAMI 2	CHILDCH CTDEET	11.00 FA 20 04LDT	24.05	CB-2	*
DMH-2	CHURCH STREET	11+96.54 20.94' RT	34.05	EX DRAIN PIPE	*
CB-2	CHURCH STREET	12+12.60 23.08' RT	33.34	DMH-2	*
	LABLE FOR EXISTING PIPES				

PROP VGC (TYPE VA4)

MEET EXIST SW

NOTE:

RET LIGHT

PROP CB-2

MEET EXIST SW

R&R LIGHT POLE

GRANITE CURB

POLE

CHURCH STREET

SAWCUT & MEET EX VGC

CONST B

STA/OFFSET FOR STRUCTURES ARE TO THE FACE OF CURB AND STRUCTURES ARE TO BE SET PER STANDARD PLANS.

CHURCH STREET

PROJECT END

STA 13+35.96

E753757.5550

N2990039.1645

10. FOR TREE PROTECTION DETAIL SEE SHEET 14.

11. FOR DRAINAGE TRENCH DETAIL SEE SHEET 14.



ADJUSTMENT, AS NECESSARY.

CONSTRUCTION NOTES:

FOR CURB TIE PLAN SEE SHEET 5.

2. FOR CONSTRUCTION DETAILS SEE SHEETS 14-16.

3. FOR WHEELCHAIR RAMP DETAILS SEE SHEET 17.

MEET EXISTING PAVEMENT WHEN REQUIRED.


PROFESSIONAL CERTIFICATION I HEREBY CERTIFY THAT THESE PLANS WERE PREPARED OR APPROVED BY ME, AND THAT I AM A DULY LICENSED PROFESSIONAL ENGINEER UNDER THE LAWS OF THE COMMONWEALTH OF MASSACHUSETTS, LICENSE NO. 49208, EXPIRATION DATE: 6/30/2022.



AREAS OUTSIDE THE LIMITS OF PROPOSED WORK DISTURBED BY THE CONTRACTOR'S OPERATIONS SHALL BE

RESTORED BY THE CONTRACTOR TO THEIR ORIGINAL CONDITION AT THE CONTRACTORS EXPENSE.

					REUSE OF DOCUMENTS		
()		ALL [DRAWI		INSTRUMENTS OF PROFESSIONAL SERVICE FOR THIS PROJECT. SE OR ALTERATION IS AT THE USER'S SOLE RISK.		
	DSGN	KMF					
5 F	DR	СВК					
	СНК	MAB					
	APVD	ELG	NO.	DATE	REVISION	BY	APVD

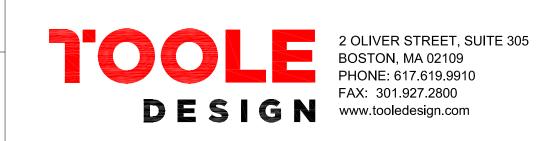

CHURCH STREET AT WATERFIELD ROAD

DATE

DRAWING NO. CONSTRUCTION PLAN SHEET NO.


FINAL DESIGN SUBMISSION

PROJECT NO.

60169


AUGUST 2021

C.01

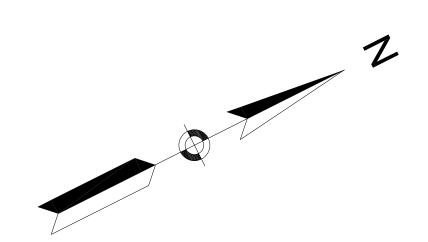

	W	ATERFIELD I	ROAD ALIGI	NMENT CONS	TRUCTION B	ASELINE I	DATA	
NUMBER	JMBER STARTING STATION NORTHING EASTING CURVE DATA LINE DATA ENDING STATION				NORTHING	EASTING		
L4	50+00.00	2989819.826	753776.415		N69°07'08"W 117.73'	51+17.73	2989861.789	753666.416

		CURVE TABLE		
CURVE#	LENGTH	DIRECTION/DELTA	RADIUS	TANGENT
1	6.56	37°36'28"	10.00	3.41
2	5.46	31°16'18"	10.00	2.80
3	22.13	84°32'41"	15.00	13.64
4	7.39	60°28'09"	7.00	4.08
5	7.42	60°43'03"	7.00	4.10
6	7.92	64°48'48"	7.00	4.44
7	7.89	64°34'13"	7.00	4.42
8	8.07	66°03'27"	7.00	4.55
9	7.85	64°16'42"	7.00	4.40
10	7.03	67°06'42"	6.00	3.98
11	6.78	64°42'37"	6.00	3.80
12	40.60	93°03'03"	25.00	26.37
13	14.09	40°22'27"	20.00	7.35
14	6.90	56°27'34"	7.00	3.76
15	7.42	60°46'02"	7.00	4.10
16	6.35	14°33'48"	25.00	3.19

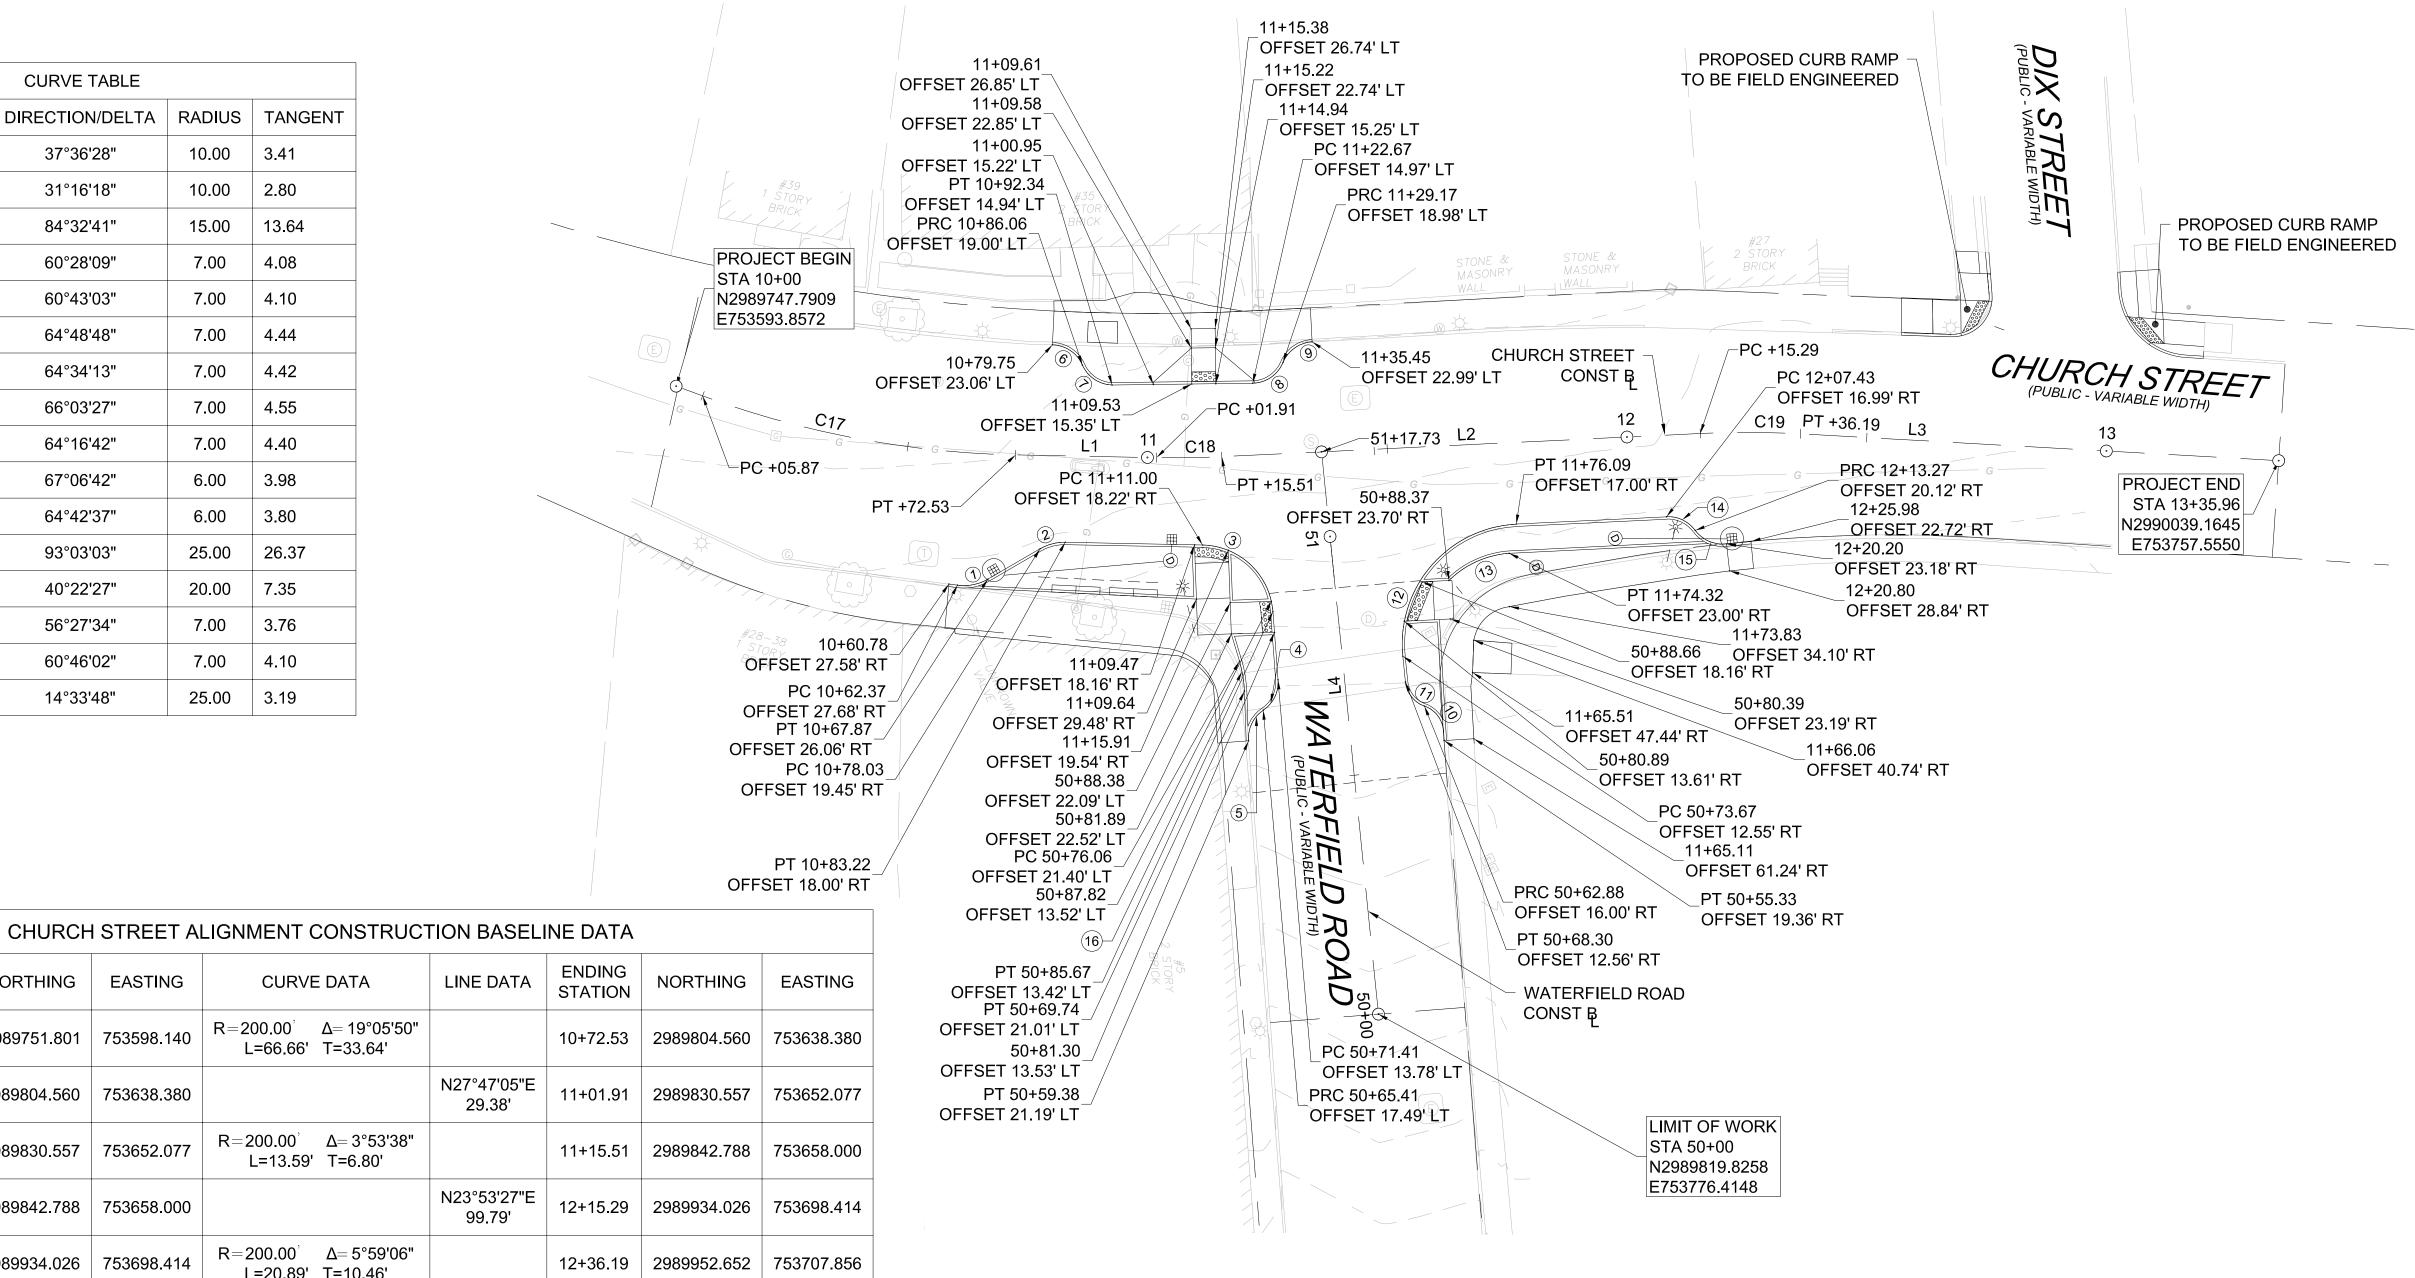

STARTING NUMBER NORTHING **EASTING** LINE DATA CURVE DATA STATION $R = 200.00^{\circ}$ $\Delta = 19^{\circ}05'50''$ 2989751.801 753598.140 10+05.87 L=66.66' T=33.64' N27°47'05"E 10+72.53 2989804.560 | 753638.380 29.38' $R = 200.00^{\circ}$ $\Delta = 3^{\circ}53'38''$ 11+01.91 2989830.557 753652.077 L=13.59' T=6.80' N23°53'27"E 11+15.51 2989842.788 | 753658.000 99.79' $R = 200.00^{\circ}$ $\Delta = 5^{\circ}59'06''$ 12+15.29 2989934.026 753698.414 L=20.89' T=10.46' N29°52'33"E 12+36.19 | 2989952.652 | 753707.856 13+35.96 | 2990039.164 | 753757.555 99.77'

DSGN

DR

CHK

APVD

MAB

ELG NO. DATE

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KMF		
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BY APVD

CHURCH STREET AT WATERFIELD ROAD


SCALE: 1" = 20'


PROJECT NO. 60169 DATE AUGUST 2021


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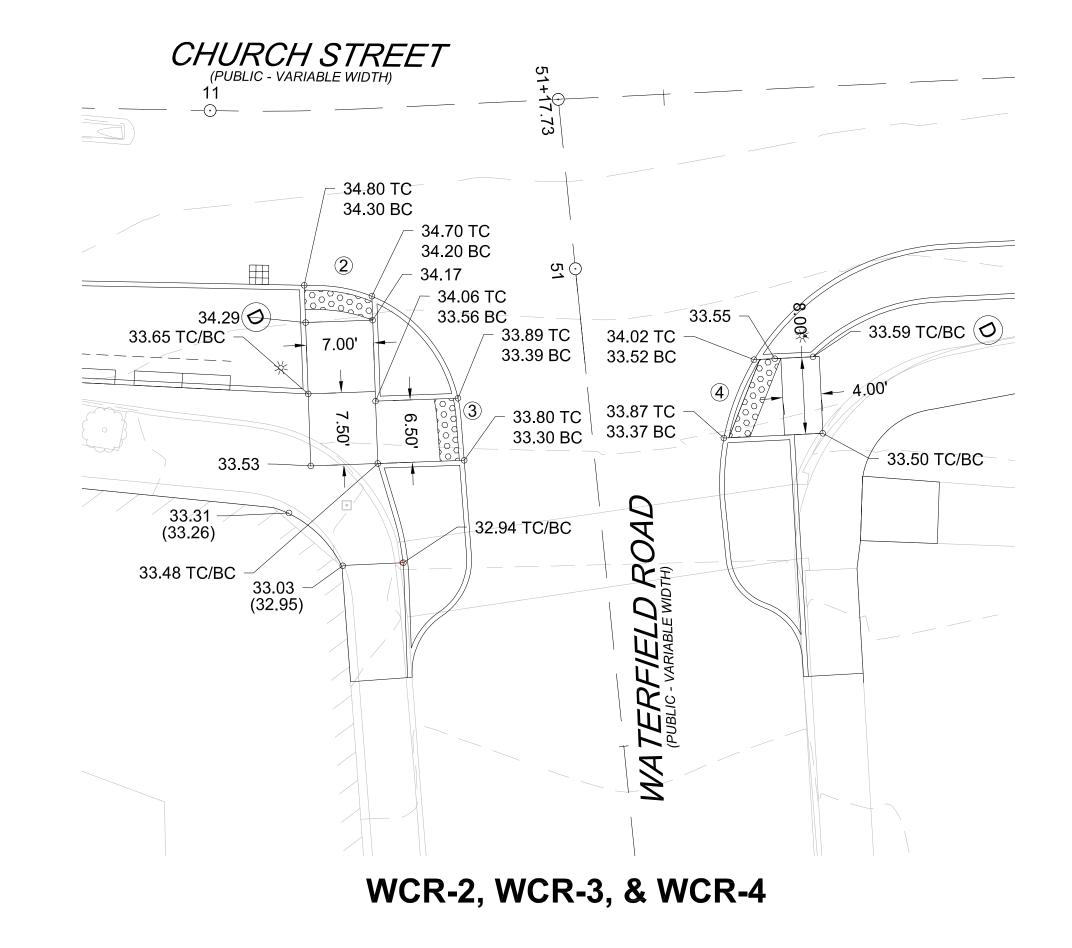
CURB TIE PLAN

DRAWING NO. CT.01 SHEET NO. 5 OF 19



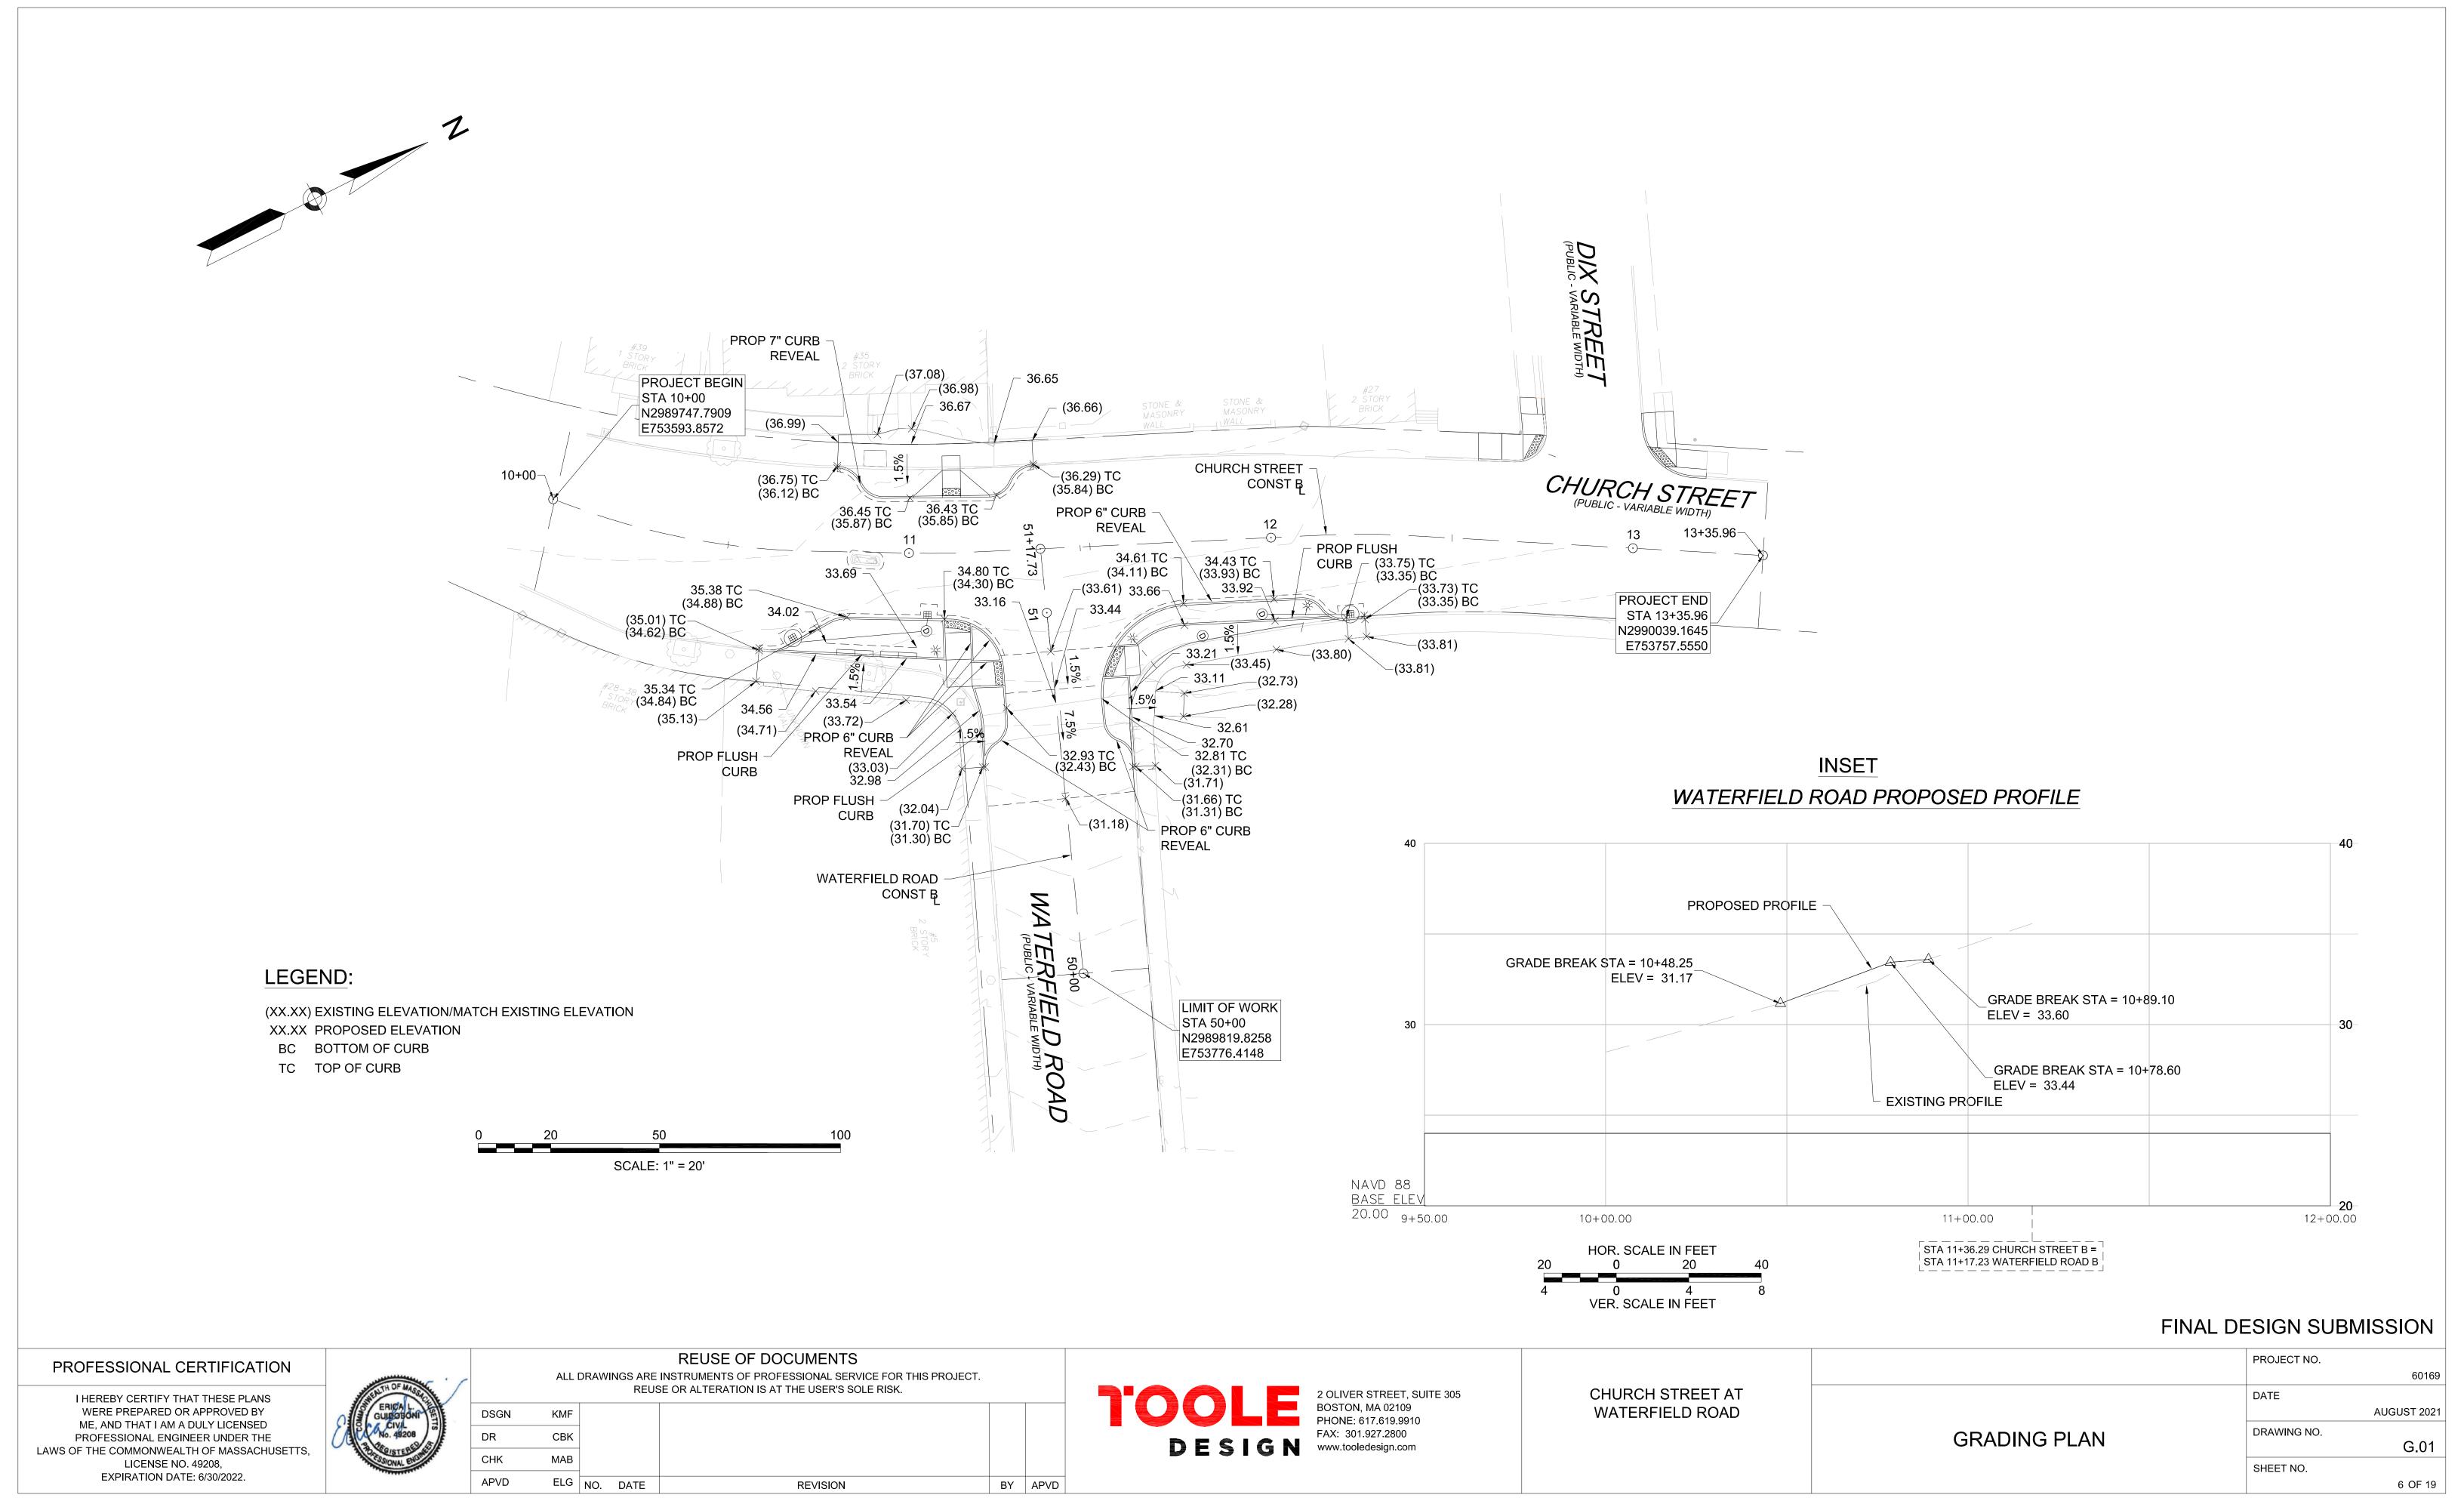

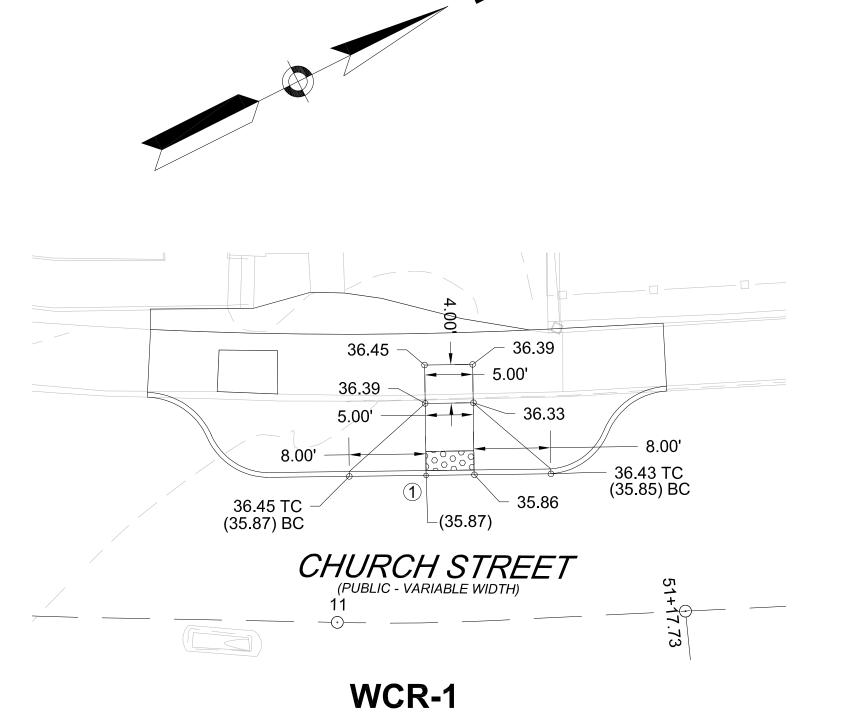

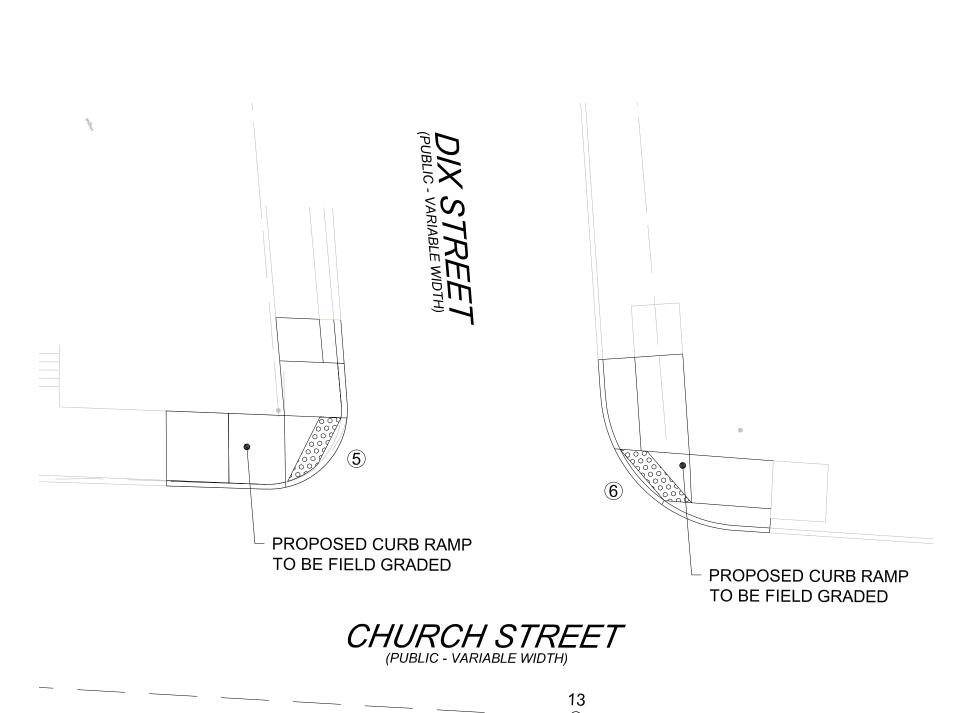

NOTES:

- 1. MAXIMUM CURB REVEAL TO BE 7", MINIMUM CURB REVEAL TO BE 4".
- 2. IN INSTANCES WHERE AN EXISTING MANHOLE, HANDHOLE OR OTHER SURFACE STRUCTURES THAT CANNOT BE REMOVED OR RESET IS WITHIN THE PROPOSED OR EXISTING CURB RAMP, THE STRUCTURE SHALL BE CAREFULLY ADJUSTED SUCH THAT THE TOPMOST SURFACE/COVER SHALL BE FLUSH WITH THE CURB RAMP SURFACE.
- 3. THE SIDEWALK CROSS SLOPE SHALL NOT EXCEED 1.5%*, INCLUDING, BUT NOT LIMITED TO , TRANSITION RAMP CROSS SLOPE, LEVEL LANDING AND THE PROPOSED RAMP OPENING.
- 4. A CURB RAMP RUNNING SLOPE SHALL NOT EXCEED 7.5%*.
- 5. PROPOSED ELEVATION AT GUTTER LINE INDICATES CHANGE OF ELEVATION FROM EXISTING ROADWAY IN ORDER TO MAINTAIN POSITIVE DRAINAGE. ADJACENT SAWCUT LINE TO MATCH EXISTING ELEVATION.
- 6. SEE SHEET 17 FOR CURB RAMP DIMENSIONS AND STATION/OFFSET REFERENCES.
- 7. ±0.5% TOLERANCE FOR SIDEWALK AND WHEELCHAIR RAMP CONSTRUCTION.


LEGEND:

(XX.XX) EXISTING ELEVATION

XX.XX PROPOSED ELEVATION

- BC BOTTOM OF CURB
- TC TOP OF CURB
- # WHEELCHAIR RAMP IDENTIFIER

WCR-5 & WCR-6

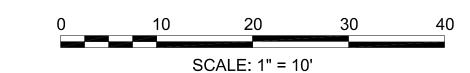


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7 OF 19

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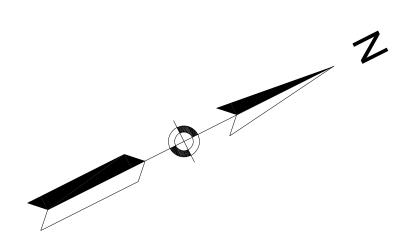



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CHK	MAB					
APVD	ELG	NO.	DATE	REVISION	BY	APVD

DESIGN www.tooledesign.com

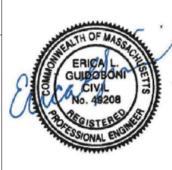CHURCH STREET AT WATERFIELD ROAD WHEELCHAIR RAMP GRADING PLAN

PROJECT NO. 60169 DATE AUGUST 2021 DRAWING NO. WCR.01 SHEET NO.



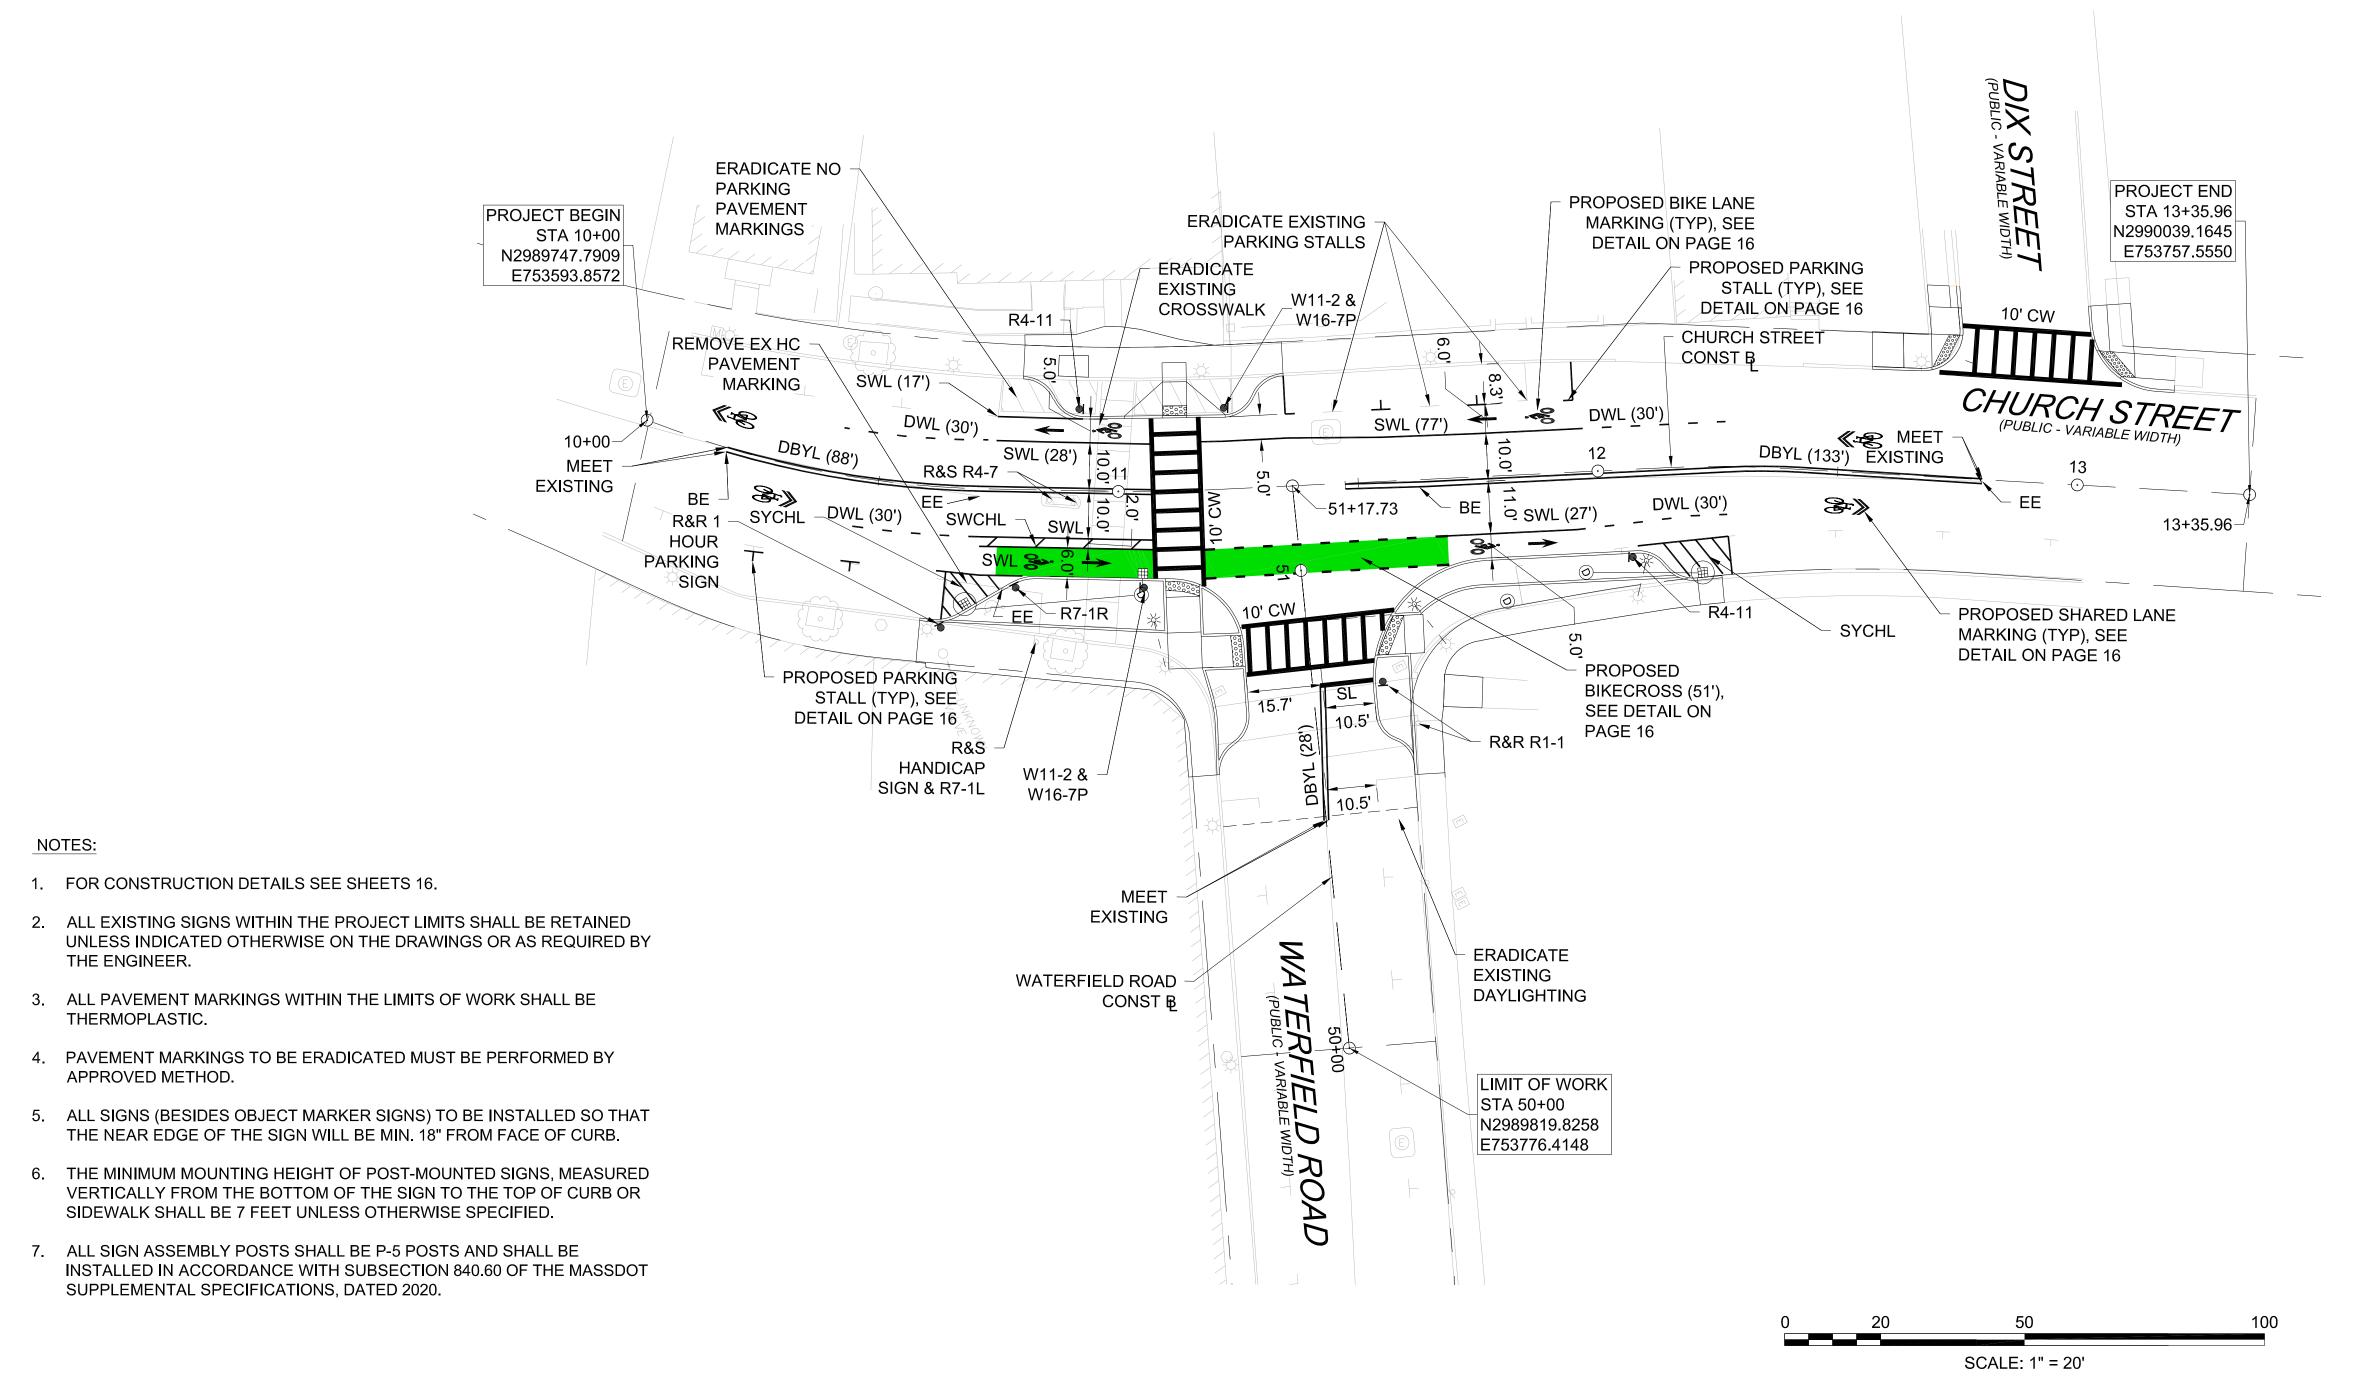

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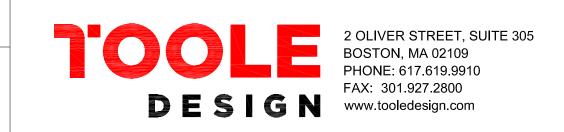
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CHK	MAB					
APVD	ELG	NO.	DATE	REVISION	BY	APVD
	DR CHK	DR CBK CHK MAB	DR CBK CHK MAB	DSGN KMF DR CBK CHK MAB	DR CBK CHK MAB	DSGN KMF DR CBK CHK MAB



CHURCH STREET AT WATERFIELD ROAD

PROJECT NO. DATE AUGUST 2021 DRAWING NO. PAVEMENT MARKING AND SIGNAGE PLAN SHEET NO.

FINAL DESIGN SUBMISSION

60169

PM.01

	SIZE OF	SIGN (in.)		TEXT DIME	NSIO	NS (in.)	NUMBER	Co	OLOR		POST SIZE		TOTAL
ID NUMBER	WIDTH	HEIGHT	LEGEND		TICAL ACING	ARROW RTE. MKR.	OF SIGNS REQUIRED	BACKGROUND	LEGEND	BORDER	AND NUMBER REQUIRED	UNIT AREA (SF)	TOTAL AREA (SF)
R4-11	30	30	MAY USE FULL LANE	SEE MUTCD S	ANDA	ARD DETAIL	2	WHITE	BLACK	BLACK	P-5 2 REQ'D	6.25	12.50
R7-1R	12	18	NO PARKING ANY TIME				1	WHITE	RED	RED	P-5 REQ'D	1.50	1.50
W11-2	30	30					2	FYG	BLACK	BLACK	P-5 2 REQ'D	6.25	12.50
W16-7P	24	12			Y		2	FYG	BLACK	BLACK	MOUNT 2 W/ W11-2	2.00	4.00

FINAL DESIGN SUBMISSION

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LICENSE NO. 49208,
EXPIRATION DATE: 6/30/2022.



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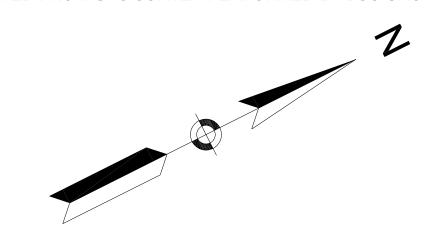
CHURCH STREET AT WATERFIELD ROAD	


PROJECT NO.	
	60169
DATE	
	AUGUST 2021
DRAWING NO.	
	PM.02
SHEET NO.	
	9 OF 19

SIGN SUMMARY

GENERAL NOTES:

- THIS PLAN IS BASED UPON AN ON-THE-GROUND SURVEY PERFORMED BY BSC GROUP, INC. IN SEPTEMBER, 2019.
- 2. HORIZONTAL DATUM IS THE NORTH AMERICAN DATUM OF 1983 (NAD 83) AS DERIVED FROM GPS SURVEY PERFORMED BY BSC GROUP, INC.
- 3. VERTICAL DATUM IS THE NORTH AMERICAN VERTICAL DATUM OF 1988 (NAVD 88) AS DERIVED FROM GPS SURVEY PERFORMED BY BSC GROUP, INC.



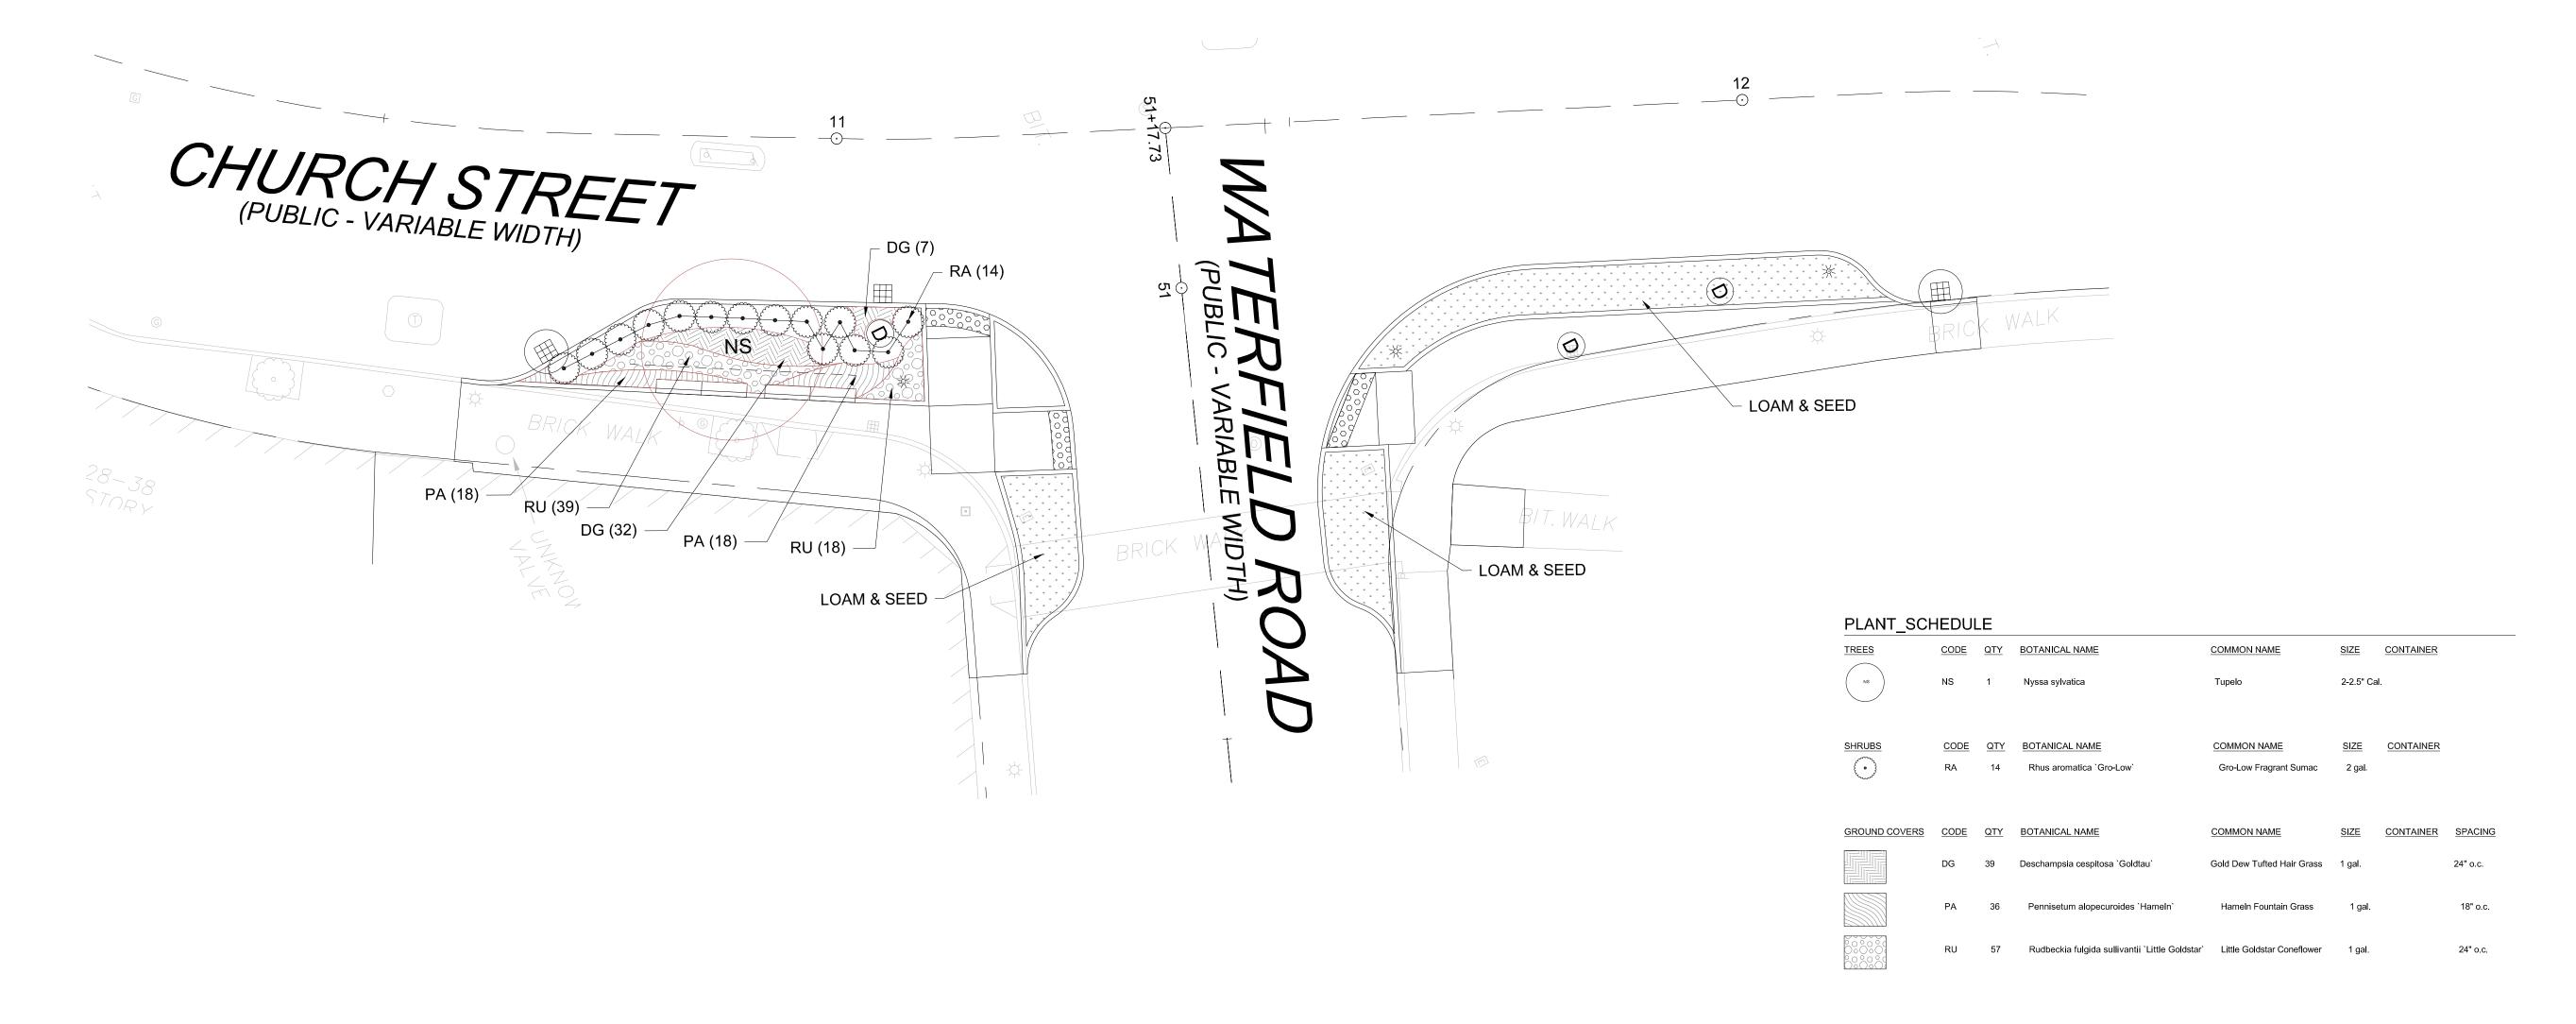



FINAL DESIGN SUBMISSION

PROJECT NO.

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DR	СВК						
CHK	MAB						
APVD	ELG	NO.	DATE	REVISION	BY	APVD	

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DESIGN	FAX: 301.927.2800 www.tooledesign.com

CHURCH STREET AT
WATERFIELD ROAD

	6016
	DATE
	AUGUST 202
PLANTING PLAN	DRAWING NO.
FLANTING FLAN	L.01

DRAWING NO.

L.01

SHEET NO.

10 OF 19

				Т	RAFFIC SIGN SUM	IMARY					
IDENTIFICATION	SIZE OF	SIGN (in)		TEXT DIMENSIONS (in)		NUMBER		COLOR		UNIT AREA	
NUMBER	WIDTH	HEIGHT	LEGEND		TICAL ARROW RTE. MKR	OF SIGNS REQUIRED	BACK- GROUND	LEGEND	BORDER	(SF)	TOTAL AREA (SF)
MA-R2-10a	48	36	WORK ZONE SPEEDING FINES DOUBLED	MASSDOT ST	ANDARD SIGN	⁴ 0	FL. RANGEWHIT	BLACK E BLACK	BLACK BLACK	12.00	48.00
MA-R2-10e	36	48	END ROAD WORK DOUBLE FINES END			⁴ 0	FL. RANGEWHIT	BLACK E BLACK	BLACK BLACK	12.00	48.00
R9-9	30	18	SIDEWALK CLOSED		MUTCD FOR ISIONS	2	WHITE	BLACK	BLACK	3.75	7.50
R9-11aL	24	12	SIDEWALK CLOSED CROSS HERE			1	WHITE	BLACK	BLACK	2.00	2.00
R9-11aR	24	12	SIDEWALK CLOSED CROSS HERE			1	WHITE	BLACK	BLACK	2.00	2.00
W1-4L	36	36				2	FL. ORANGE	BLACK	BLACK	9.00	18.00
W1-4R	36	36				2	FL. ORANGE	BLACK	BLACK	9.00	18.00
W5-1	36	36	ROAD			2	FL. ORANGE	BLACK	BLACK	9.00	18.00
W11-2	30	30				4	FYG	BLACK	BLACK	6.25	25.00
W16-7pL	24	12				4	FYG	BLACK	BLACK	2.00	8.00
W20-1	36	36	ROAD WORK			4	FL. ORANGE	BLACK	BLACK	9.00	36.00
W20-4	36	36	ONE LANE ROAD AHEAD			4	FL. ORANGE	BLACK	BLACK	9.00	36.00
W20-7a	36	36				4	FL. ORANGE	BLACK	BLACK	9.00	36.00
W21-5a	36	36	RIGHT SHOULDER CLOSED			4	FL. ORANGE	BLACK	BLACK	9.00	36.00

	TRAFFIC SIGN SUMMARY											
IDENTIFICATION	SIZE OF SIGN (in)		TEXT DIMENSIONS (in)		NUMBER OF SIGNS	COLOR		UNIT AREA	TOTAL AREA			
NUMBER	WIDTH	HEIGHT	LEGEND	LETTER HEIGHT	VERTICAL SPACING	ARROW RTE. MKR	REQUIRED	BACK- GROUND	LEGEND	BORDER	(SF)	(SF)
MA-W20-7b	36	36	POLICE OFFICER AHEAD	MASSDOT STANDARD SIGN		4	FL. ORANGE	BLACK	BLACK	9.00	36.00	

NOTES:

- 1. ALL TEMPORARY TRAFFIC CONTROL WORK SHALL CONFORM TO THE LATEST EDITION OF THE "MANUAL ON UNIFORM TRAFFIC CONTROL DEVICES" (MUTCD) AND ALL REVISIONS, UNLESS SUPERCEDED WITH THE MUTCD.
- 2. ALL SIGN LEGENDS, BORDERS, AND MOUNTING SHALL BE IN ACCORDANCE WITH THE MUTCD.
- 3. TEMPORARY CONSTRUCTION SIGNING, AND ALL OTHER TRAFFIC CONTROL DEVICES SHALL BE IN PLACE PRIOR TO THE START OF ANY WORK.
- 4. TEMPORARY CONSTRUCTION SIGNING, BARRICADES, AND ALL OTHER NECESSARY WORK ZONE TRAFFIC CONTROL DEVICES SHALL BE REMOVED FROM THE HIGHWAY OR COVERED WHEN THEY ARE NOT REQUIRED FOR CONTROL OR TRAFFIC.
- 5. SIGNS AND SIGN SUPPORTS LOCATED ON OR NEAR THE TRAVELED WAY, CHANNELIZING DEVICES, BARRIERS, AND CRASH ATTENUATORS MUST PASS THE CRITERIA SE FORTH IN NCHRP REPORT 350, "RECOMMENDED PROCEDURES FOR THE SAFETY PERFORMANCE EVALUATION OF HIGHWAY FEATURES" AND/OR "MANUAL FOR ASSESSING SAFETY HARDWARE" (MASH).
- 6. CONTRACTORS SHALL NOTIFY EACH ABUTTER AT LEAST 24 HOURS IN ADVANCE OF THE START OF ANY WORK THAT WILL REQUIRE THE TEMPORARY CLOSURE OF ACCESS, SUCH AS CONDUIT INSTALLATION, EXISTING PAVEMENT EXCAVATION, TEMPORARY DRIVEWAY PAVEMENT PLACEMENT, AND SIMILAR OPERATIONS.
- 7. THE FIRST FIVE PLASTIC DRUMS OF A TAPER SHALL BE MOUNTED WITH TYPE A LIGHTS.
- 8. THE ADVISORY SPEED LIMIT, IF REQUIRED, SHALL BE DETERMINED BY THE ENGINEER.
- 9. DISTANCES ARE A GUIDE AND MAY BE ADJUSTED IN THE FIELD BY THE ENGINEER.
- 10. MAXIMUM SPACING OF TRAFFIC DEVICES IN A TAPER (DRUMS OR CONES) IS EQUAL IN FEET TO THE SPEED LIMIT IN MPH.
- 11. MINIMUM LANE WIDTH IS TO BE 11 FEET (3.3M) UNLESS OTHERWISE SHOWN. MINIMUM LANE WIDTH TO BE MEASURED FROM THE EDGE OF DRUMS OR MEDIAN BARRIER.
- 12. ALL SIGNS SHALL BE MOUNTED ON THEIR OWN STANDARD SIGN SUPPORTS.

NOTES:

- 1. ALL CONSTRUCTION SIGNING, DRUMS, BARRICADES AND OTHER DEVICES SHALL CONFORM WITH THE 2009 MANUAL ON UNIFORM TRAFFIC CONTROL DEVICES (M.U.T.C.D.) AS AMENDED.
- 2. ALL DRUMS SHALL BE APPROXIMATELY PLACED AND MOVED AS NECESSARY TO MAINTAIN ADEQUATE ABUTTER ACCESS AT ALL TIMES. WORK MAY REQUIRE ADDITIONAL SIGNS, DRUMS AND OTHER TRAFFIC CONTROL DEVICES, GRADING AND TEMPORARY PAVEMENT FOR PASSAGE OF PEDESTRIAN, VEHICULAR AND EMERGENCY TRAFFIC THROUGH THE WORK AREAS, BOTH DURING AND AFTER WORKING HOURS, TO MAINTAIN SUCH ACCESS. THE FIRST TEN DRUMS SHALL BE MOUNTED WITH SEQUENTIAL FLASHING LIGHTS. MAX SPACING OF DRUMS/CONES IS EQUAL IN FEET TO THE SPEED LIMIT IN MPH.
- 3. THE CONTRACTOR SHALL NOTIFY EACH ABUTTER AT LEAST 24 HOURS IN ADVANCE OF THE START OF ANY WORK THAT WILL REQUIRE THE TEMPORARY CLOSURE OF ACCESS, SUCH AS CONDUIT INSTALLATION, EXISTING PAVEMENT EXCAVATION, TEMPORARY DRIVEWAY PAVEMENT PLACEMENT AND SIMILAR OPERATIONS.
- 4. A MINIMUM OF ONE LANE OF TRAFFIC IN EACH DIRECTION ON TWO WAY STREETS SHALL BE MAINTAINED AT ALL TIMES. EXCEPT AT PEAK HOURS, TRAFFIC DURING WORKING HOURS MAY BE REDUCED TO ONE LANE UNDER POLICE CONTROL FOR SHORT TIME PERIODS WHEN REQUIRED FOR THE WORK, AS APPROVED BY MASSDOT.
- 5. GRADE SEPARATIONS IN EXCESS OF 2" DURING NON-WORKING HOURS SHALL REQUIRE DELINEATION BY USE OF DRUMS.
- 6. EXCAVATION EDGES IN EXCESS OF 4" DEEP SHALL BE PROTECTED DURING NON-WORKING HOURS BY BACKFILLING WITH A WEDGE OF GRAVEL OR SOIL TO COMPACTED 4:1 SLOPE.
- 7. 11' MINIMUM LANE WIDTHS SHALL BE MAINTAINED AT ALL TIMES.
- 8. NON-ESSENTIAL TRAFFIC CONTROL DEVICES SHALL BE COVERED OR REMOVED DURING NON-WORKING HOURS.
- 9. FLAGGERS MAY NOT BE USED FOR TRAFFIC CONTROL AT INTERSECTIONS.
- 10. SEE SHEET 21 FOR PEDESTRIAN TRAFFIC CONTROL DETAILS.
- 11. CONTRACTOR SHALL MAINTAIN ADA-COMPLIANT PEDESTRIAN ACCESS AT ALL TIMES, SPECIFICALLY INCLUDING PEDESTRIAN GUIDANCE SYSTEMS AT WORK ZONES. ACCESS SHALL BE MAINTAINED ALONG ALL SIDEWALKS AND CROSSWALKS, TO ALL ABUTTERS, AND TO ALL MBTA BUS STOPS OR TRAIN STATIONS. ANY PEDESTRIAN DETOURS SHALL INCLUDE A FULLY ADA-COMPLIANT PEDESTRIAN DETOUR ROUTE WITH PROPER BARRICADES, RAILINGS, RAMPS, AND SIGNAGE.

FINAL DESIGN SUBMISSION

PROJECT NO.

60169

AUGUST 2021

TTCP.01

11 OF 19

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DSGN

DR

CHK

APVD

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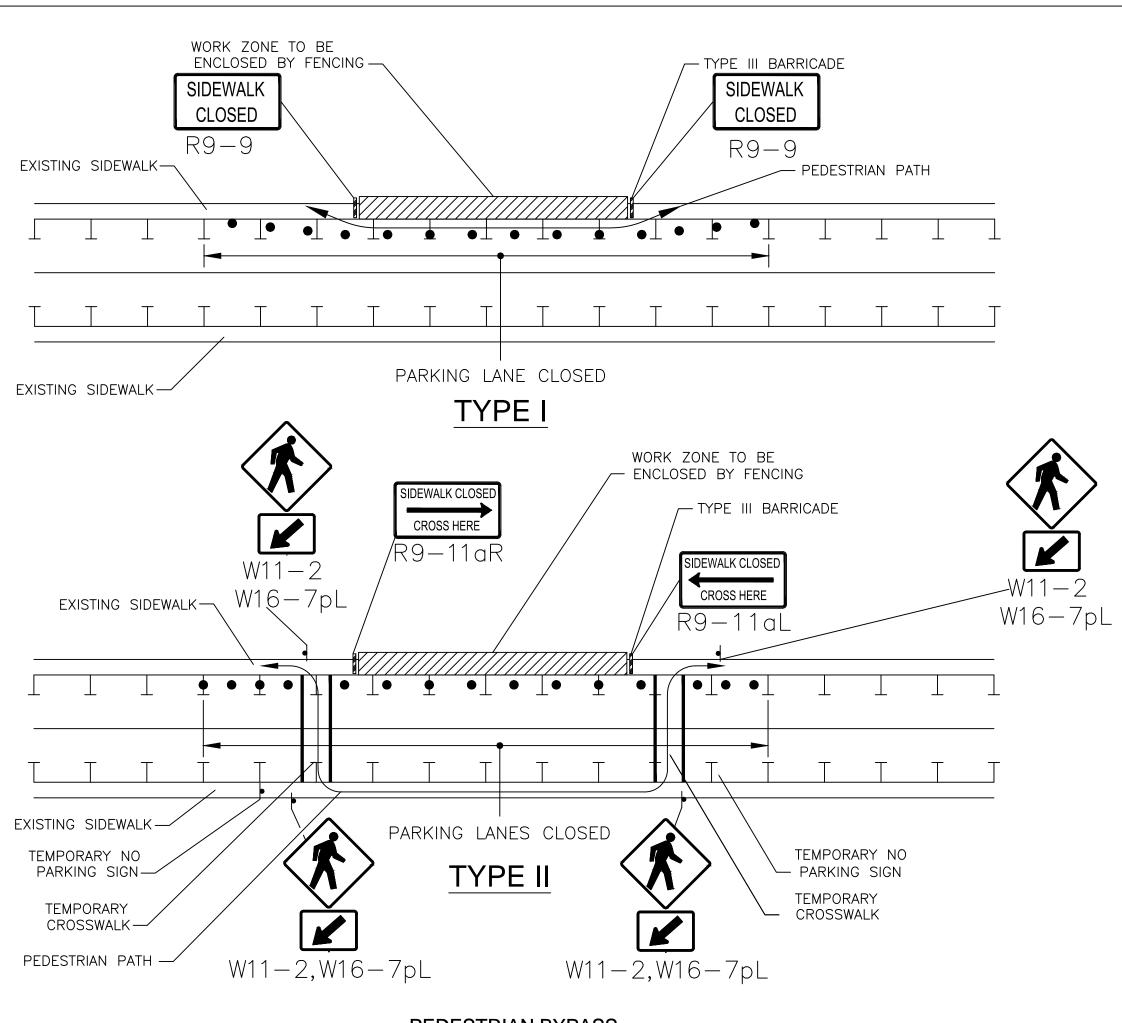
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KMF								
CBK								
MAB								
ELG	NO. DATE	REVISION	BY	APVD				



CHURCH STREET AT WATERFIELD ROAD

TEMPORARY TRAFFIC CONTROL PLAN

DRAWING NO.
SHEET NO.




PEDESTRIAN BYPASS

NTS ADDITIONAL ADVANCE WARNING MAY BE NECESSARY.

CONTROLS ONLY FOR PEDESTRIAN TRAFFIC ARE SHOWN. VEHICULAR TRAFFIC SHOULD BE HANDLED AS SHOWN ELSEWHERE.

- STREET LIGHTING SHOULD BE CONSIDERED WHEN LOCATING CONTROL DEVICES.
- 4. IF THE WORK ZONE DOES NOT PERMIT PEDESTRIANS TO TRAVEL ADJACENT TO IT AS SHOWN IN PEDESTRIAN BYPASS TYPE I, TEMPORARY CROSSWALKS WITH APPROPRIATE SIGNS SHOULD BE INSTALLED TO CROSS PEDESTRIANS TO THE OPPOSITE SIDE OF THE STREET AS SHOWN IN PEDESTRIAN BYPASS TYPE II, AND AS DIRECTED BY THE ENGINEER. TEMPORARY CURB RAMPS WILL BE REQUIRED AT ALL TEMPORARY CROSSWALK LOCATIONS.
- 5. BYPASS IS TO BE USED IN CONJUCTION WITH THE PROPOSED LANE CLOSURE DETAILS AND DURING CONSTRUCTION STAGING, AS DIRECTED
- BY THE ENGINEER.
- 6. THE TEMPORARY SIDEWALK SHOULD BE A MINIMUM OF 4 FEET WIDE. IF THIS WALKWAY EXCEEDS 200 FEET THEN A 5 FOOT X 5 FOOT PASSING ZONE. (FOR SHORT TERM SETUPS < 10 HOURS, THIS CONDITION MAY BE WAIVED. A NOTE WOULD NEED TO BE INCLUDED IN THE TTCP THAT STATES HOW THE CONTRACTOR SHOULD ADDRESS THIS ISSUE.)

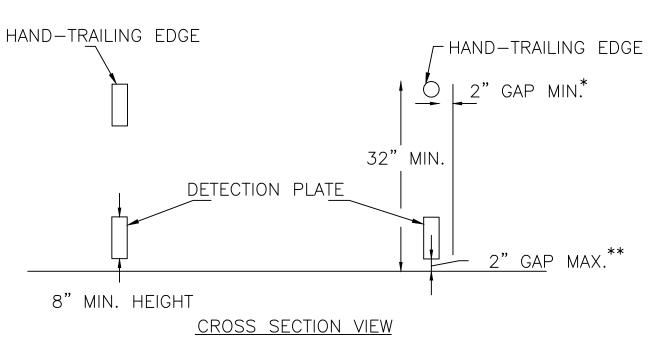


PEDESTRIAN CHANNELIZING DEVICE


NOTES:

- * THERE SHALL BE A 2 INCH GAP BETWEEN THE
- HAND-TRAILING EDGE AND ITS SUPPORT.

 ** A MAXIMUM 2 INCH GAP BETWEEN THE BOTTOM OF THE BOTTOM RAIL AND THE SURFACE MAY BE

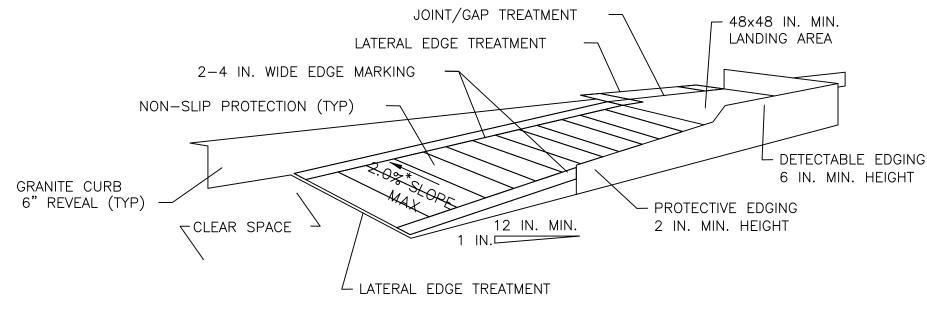

TEMPORARY CURB RAMP-PARALLEL TO CURB NTS

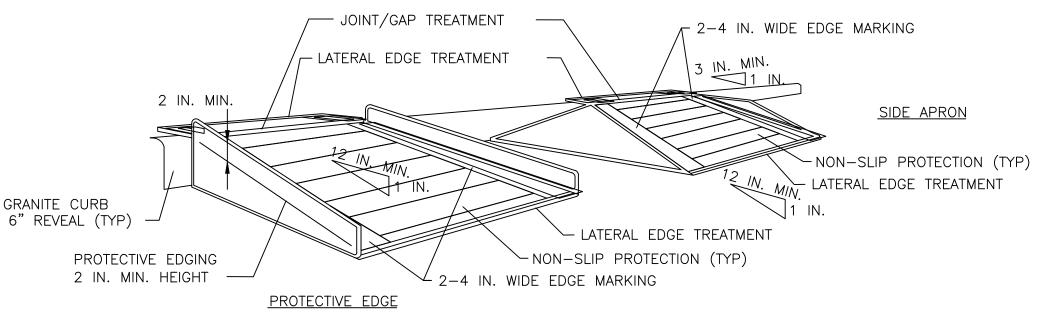

TEMPORARY CURB RAMP-PERPENDICULAR TO CURB


1. CURB RAMPS SHALL BE 60 IN. MINIMUM WIDTH WITH A FIRM, STABLE AND NON-SLIP SURFACE.


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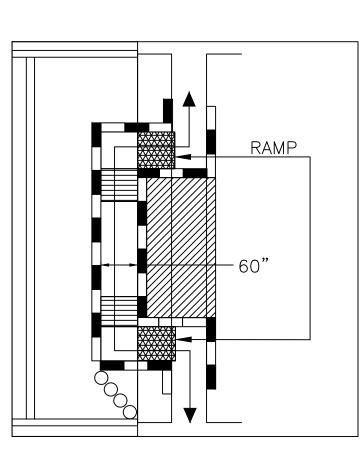
- 2. PROTECTIVE EDGING WITH A 2 IN. MINIMUM HEIGHT SHALL BE INSTALLED WHEN THE CURB RAMP OR LANDING PLATFORM HAS A VERTICAL DROP OF 6 IN. OR GREATER OR HAS A SIDE APRON SLOP STEEPER THAN 1:3 (33%). PROTECTIVE EDGING SHOULD BE CONSIDERED WHEN THE CURB RAMPS OR LANDING PLATFORMS HAVE A VERTICAL DROP OF 3 IN. OR MORE.
- DETECTABLE EDGING WITH 6 IN. MINIMUM HEIGHT AND CONTRASTING COLOR SHALL BE INSTALLED ON ALL CURB RAMP LANDINGS WHERE THE WALKWAY CHANGES DIRECTION
- CURB RAMPS AND LANDINGS SHOULD HAVE A 1:50 (2%) MAX CROSS-SLOPE.
- 5. CLEAR SPACE OF 48x48 IN. MINIMUM SHALL BE PROVIDED ABOVE AND BELOW THE CURB RAMP.
- CONTRASTING COLOR 2 TO 4 IN. WIDE MARKING. THE MARKING IS OPTIONAL WHERE COLOR CONTRASTING EDGING IS USED.

THE CURB RAMP WALKWAY EDGE SHALL BE MARKED WITH A

- 7. WATER FLOW IN THE GUTTER SYSTEM SHALL HAVE MINIMAL RESTRICTION.
- 8. LATERAL JOINTS OR GAPS BETWEEN SURFACES SHALL BE LESS THAN 0.5 IN. WIDTH.
- 9. CHANGES BETWEEN SURFACE HEIGHTS SHOULD NOT EXCEED 0.5 IN. LATERAL EDGES SHOULD BE VERTICAL UP TO 0.25 IN. HIGH, AND BEVELED AT 1:2 BETWEEN 0.25 IN. AND 0.5 IN. HEIGHT.



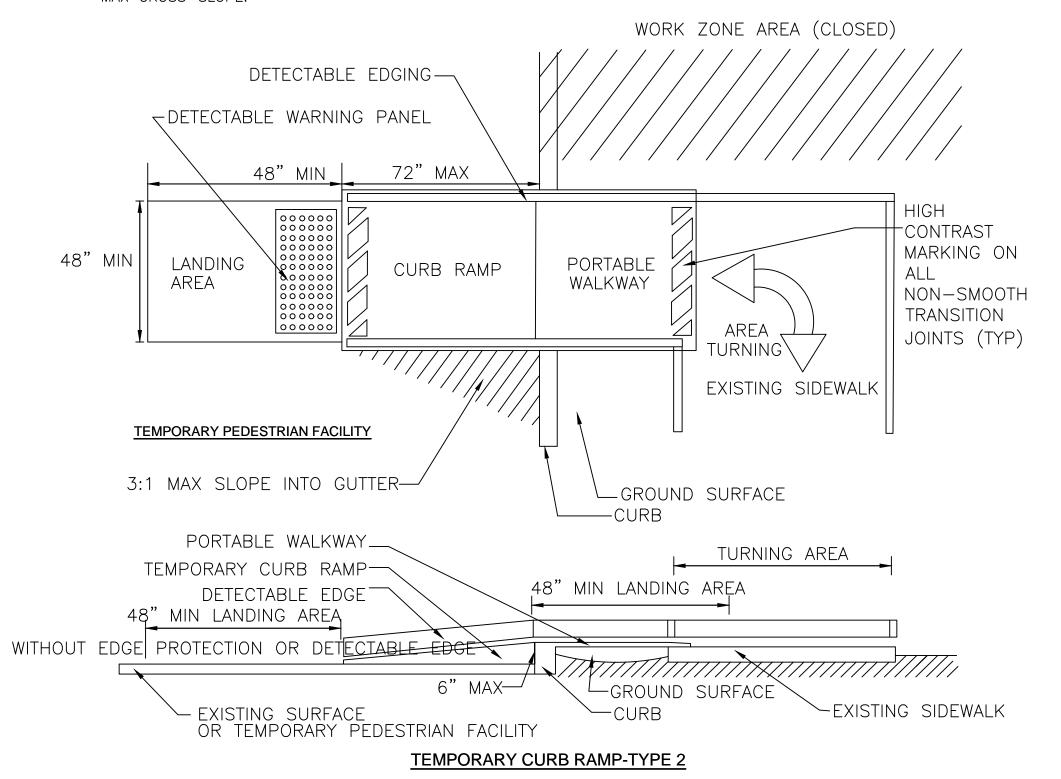

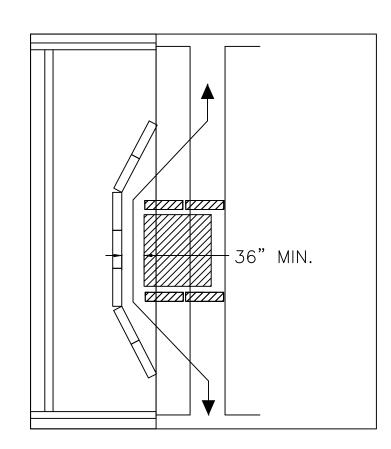

PEDESTRIAN BYPASS

- When existing pedestrian facilities are disrupted, closed, or relocated in a TTC zone, temporary facilities shall be provided and they shall be detectable and include accessibility
- features consistent with the features present in the existing pedestrian facility. A pedestrian channelizing device that is detectable by a person with a visual disability traveling with the aid of a long cane shall be placed across the full width of the closed
- When used, temporary ramps shall comply with Americans with Disabilities Act (see Figures
- Ped-1 & Ped-2). The alternate pathway should have a smooth continuous hard surface for the entire length of the temporary pedestrian facility.
- The protective requirements of a TTC situation have priority in determining the need for temporary traffic barriers and their use in this situation should be based on engineering judgment.
- Audible information devices should be considered where midblock closings and changed crosswalk areas cause inadequate communication to be provided to pedestrians who have visual disabilities.

AUDIBLE DEVICES

For long term sidewalk closures (at a minimum overnight) a form of speech messaging for pedestrians with visual disabilities shall be provided. Audible information devices such as detectable barriers or barricades and other passive pedestrian activation (motion activated) devices should be considered for these cases. These audible devices can be mountable or stand alone.

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PROJECT NO.


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USED TO PROVIDE DRAINAGE.


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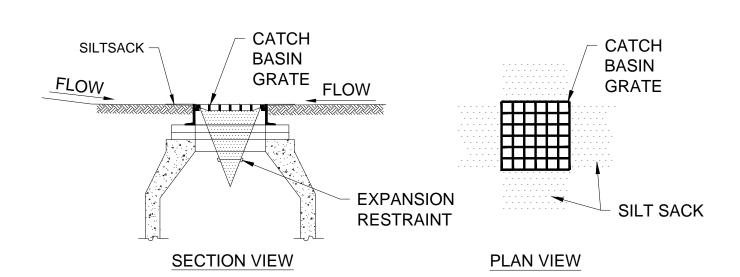


CHURCH STREET AT WATERFIELD ROAD

TEMPORARY TRAFFIC CONTROL PLAN

60169 DATE AUGUST 2021 DRAWING NO. TTCP.02 SHEET NO. 12 OF 19

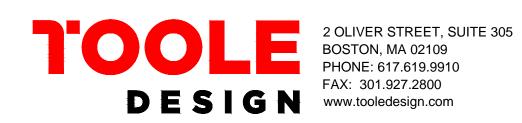


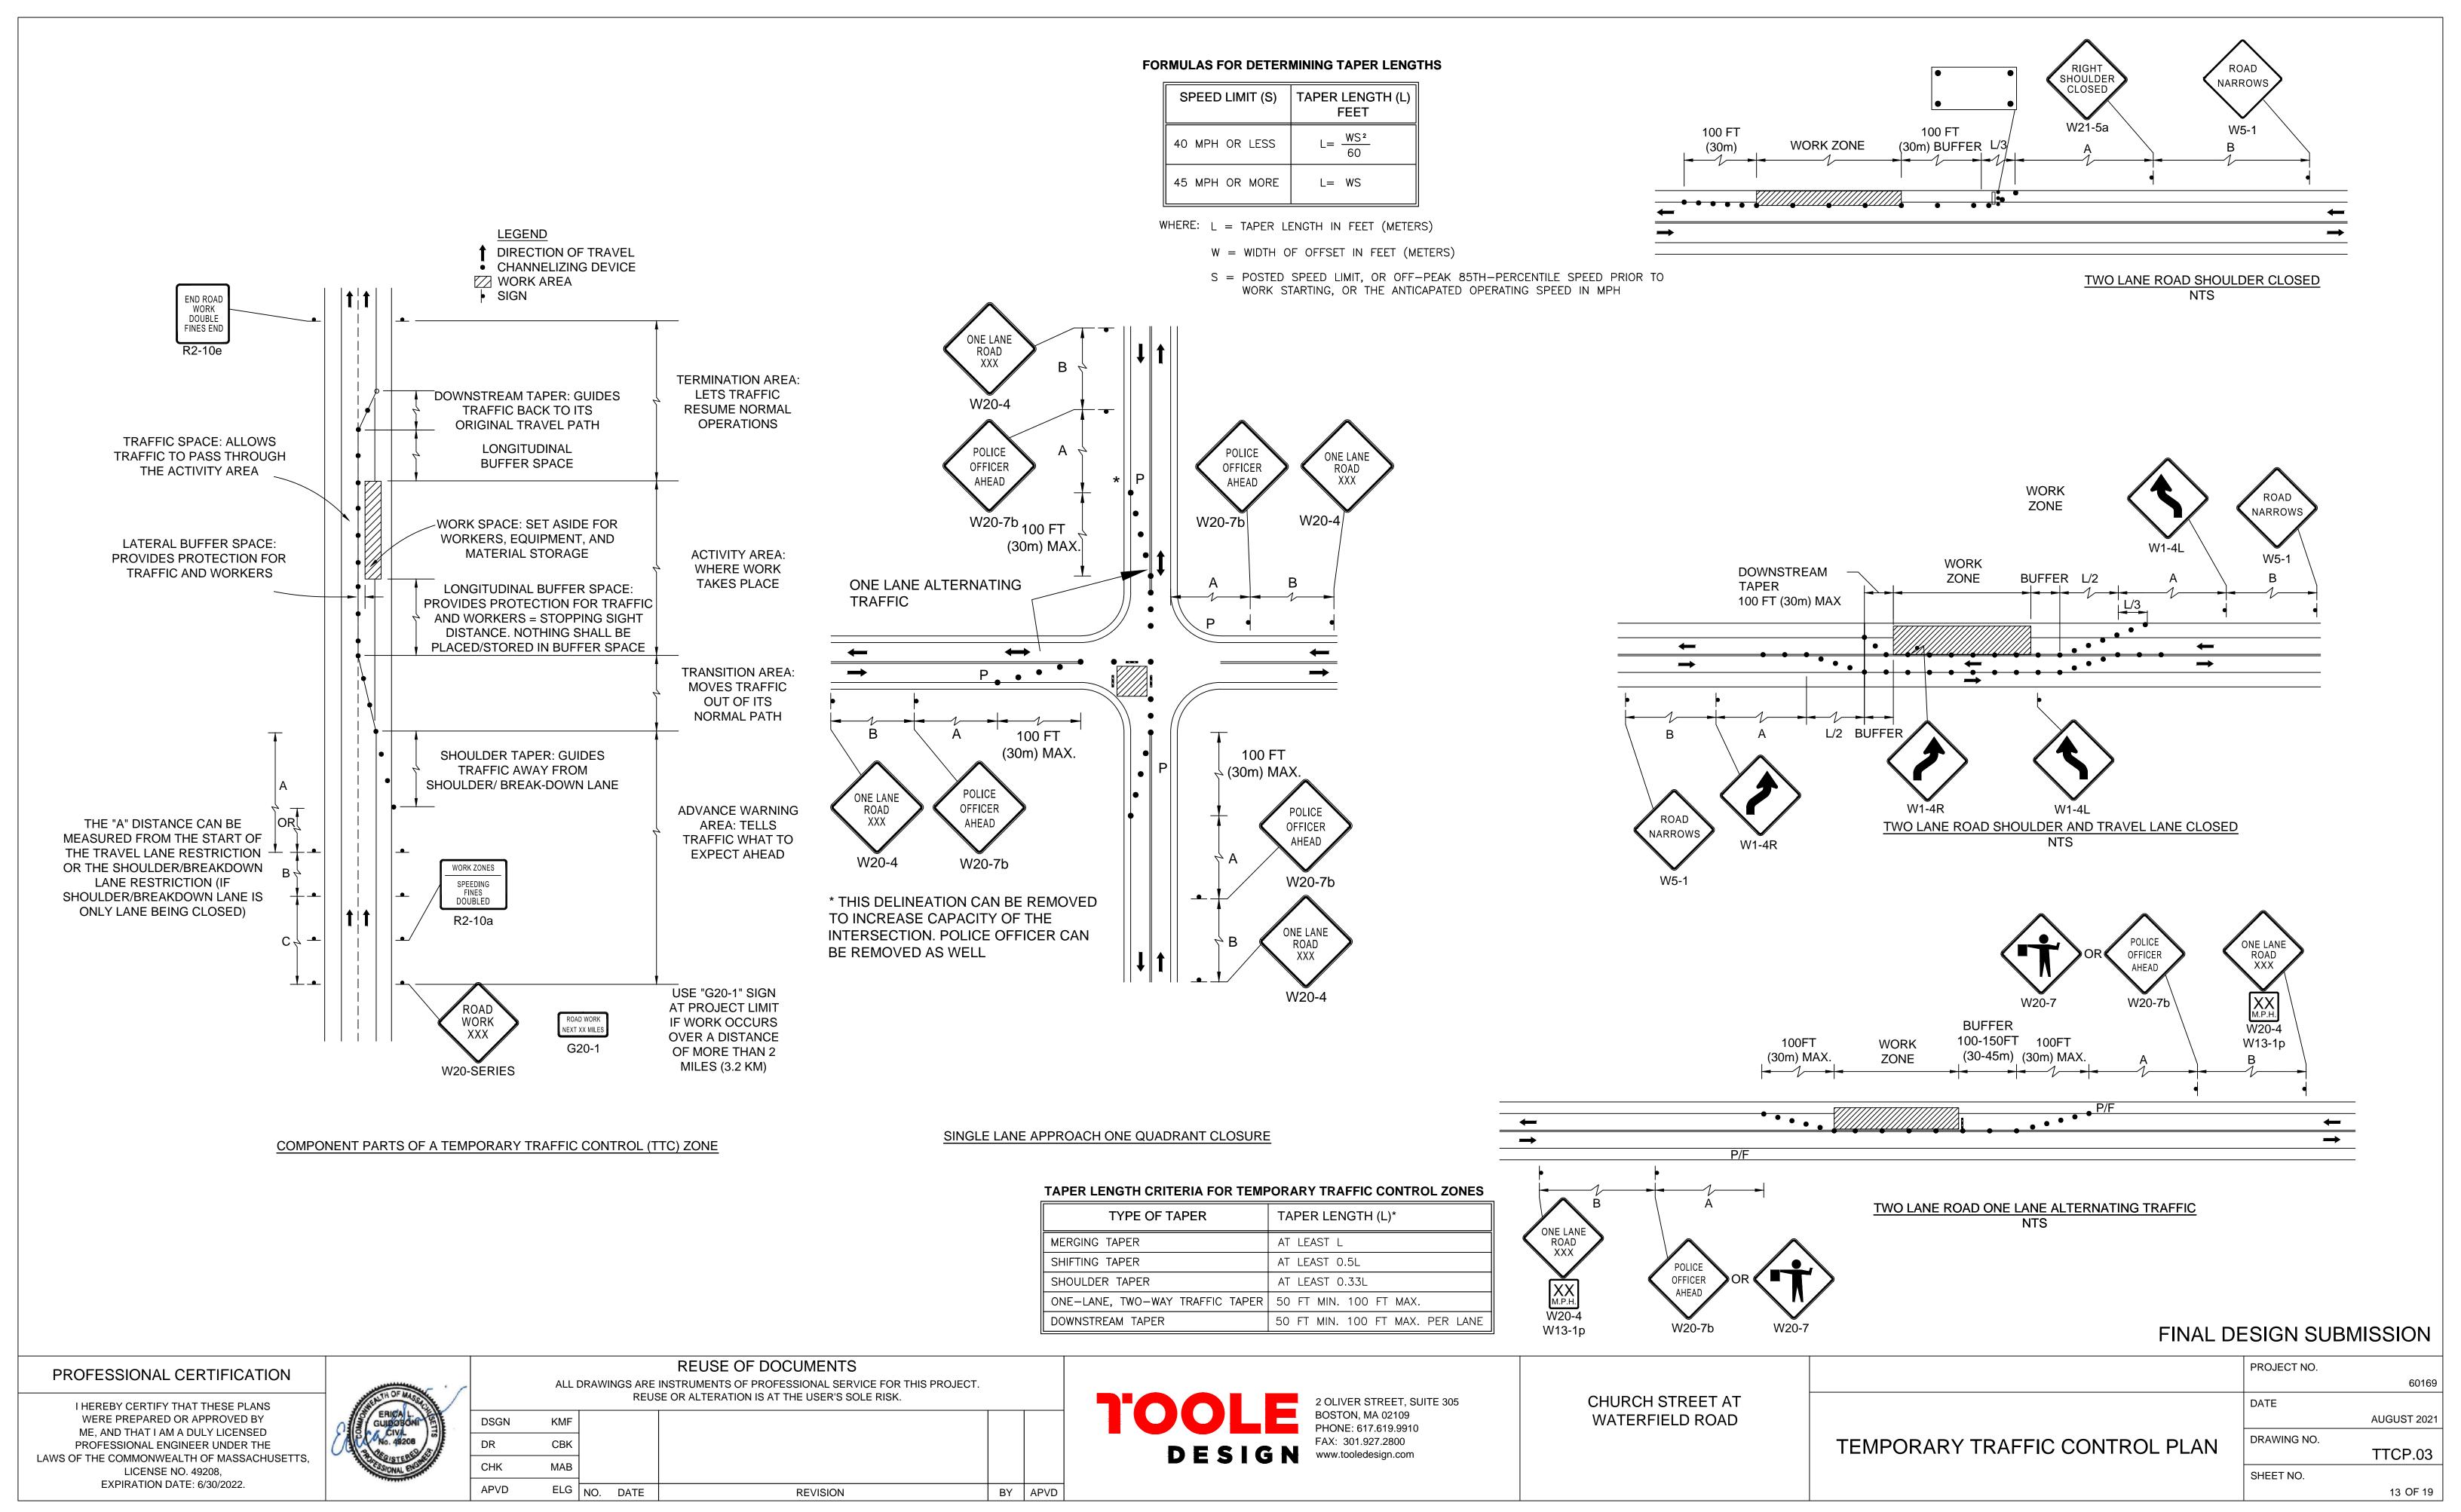

NOTES:

- INSTALL SILT SACK IN EXISTING CATCH BASINS BEFORE COMMENCING WORK, AND IN NEW CATCH BASINS IMMEDIATELY AFTER INSTALLATION OF STRUCTURE. MAINTAIN UNTIL BINDER COURSE PAVING IS COMPLETE OR A PERMANENT STAND OF GRASS HAS BEEN ESTABLISHED.
- GRATE TO BE PLACED OVER SILT SACK.
- SILTSACK SHALL BE INSPECTED PERIODICALLY AND AFTER ALL STORM EVENTS AND CLEANING OR REPLACEMENT SHALL BE PERFORMED PROMPTLY AS NEEDED.


INLET PROTECTION SILT SACK IN CATCH BASIN NOT TO SCALE

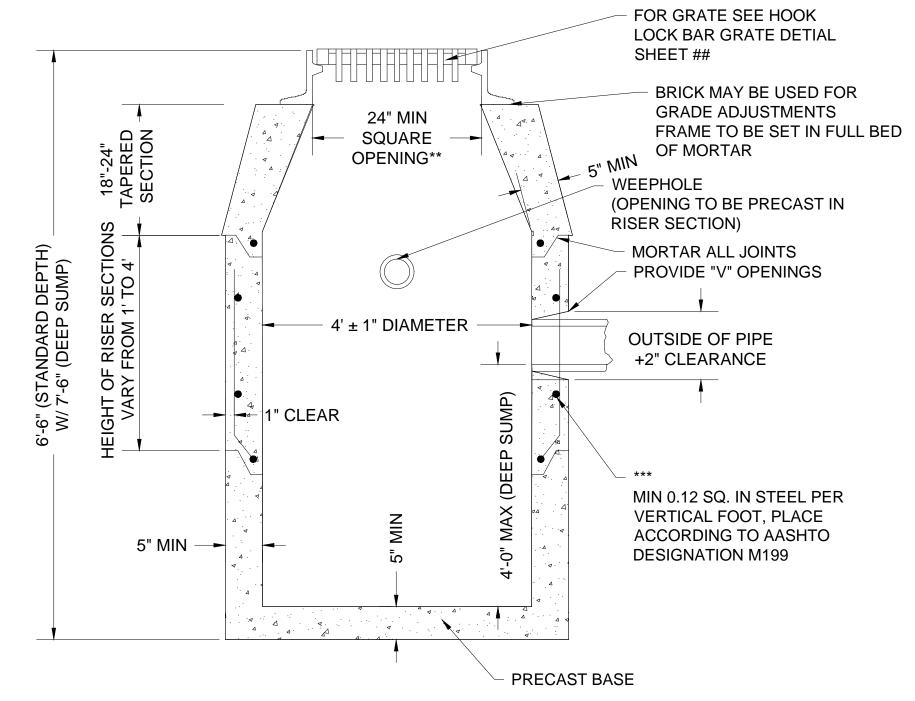


- MINIMUM DEPTH OF SUMP TO BE 4 FT
- ** WHEN A CURB INLET IS INSTALLED, THE OPENING IS TO BE
- 24"±1"X27"±1" *** REINFORCING STEEL BASED ON A WALL THICKNESS OF 5"

PRECAST CONCRETE CATCH BASIN

NOT TO SCALE

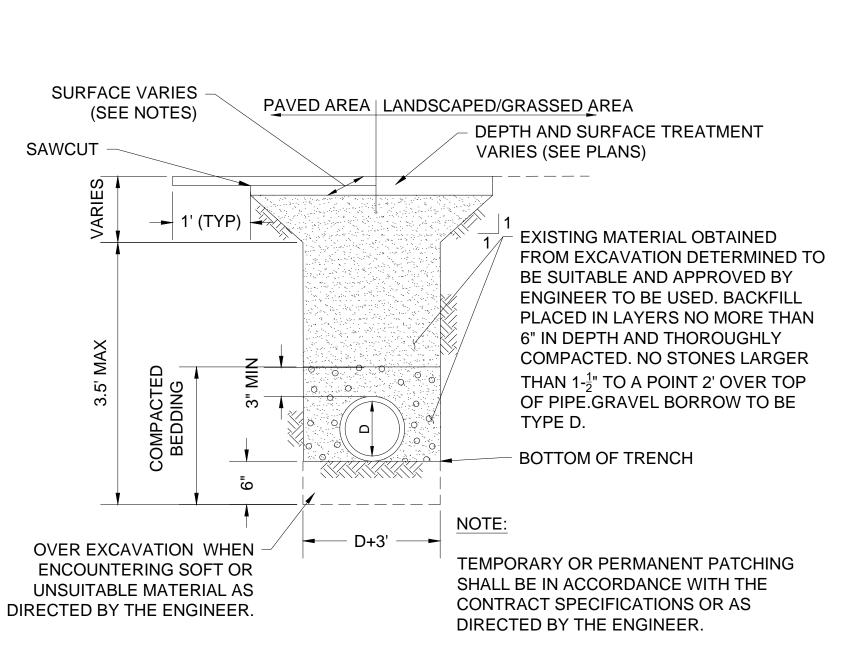

DRAINAGE TRENCH NOT TO SCALE

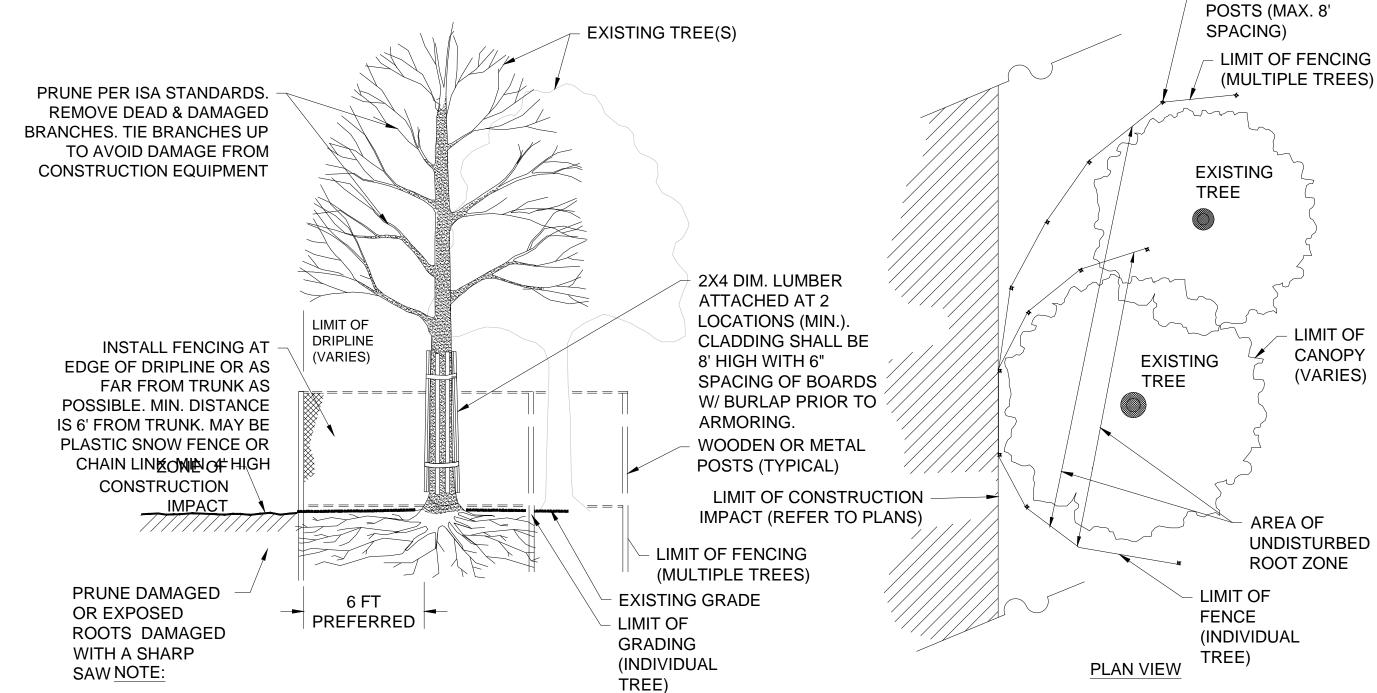

NO STORAGE OF EQUIPMENT OR STOCKPILING OF MATERIALS WITHIN DRIPLINE OF THE TREE IS ALLOWED.

TREE PROTECTION - EXISTING TREE

FINAL DESIGN SUBMISSION NOT TO SCALE

→ GUTTER LINE →

MIN

* CONCRETE SHALL BE INCLUDED IN PRICE BID FOR VARIOUS GRANITE CURB ITEMS FOR 6" OFFSET FROM FACE OF CURB.

NOTE: ADDITIONAL CONCRETE SUPPORT SHALL BE

GRANITE CURB IN EXISTING PAVEMENT

NOT TO SCALE

PROVIDED FOR STABILITY OF GRANITE CURB.

WOODEN OR METAL

HMA FULL DEPTH (<4' WIDE)

EXISTING PAVEMENT

CONCRETE BASE COURSE

GRAVEL BORROW TYPE C

SAWCUT

(SEE PAVEMENT NOTES ON SHEET 3)

HIGH EARLY STRENGTH CEMENT

PROP GRANITE CURB

TREATMENT VARIES

(SEE PLANS)

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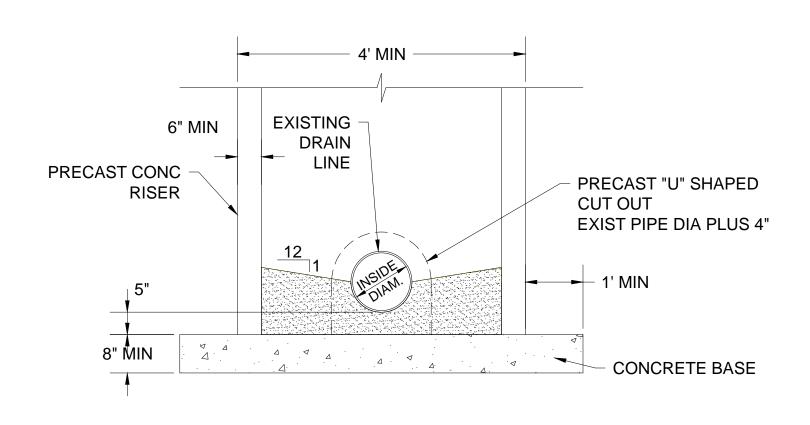
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	CHK	MAB								
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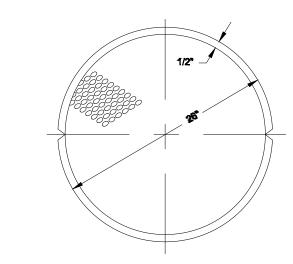
CHURCH STREET AT WATERFIELD ROAD

CONSTRUCTION DETAILS


PROJECT NO. 60169 DATE AUGUST 2021 DRAWING NO. CD.01 SHEET NO.



PRECAST MANHOLE OVER EXISTING DRAIN LINE



STANDARD COVER

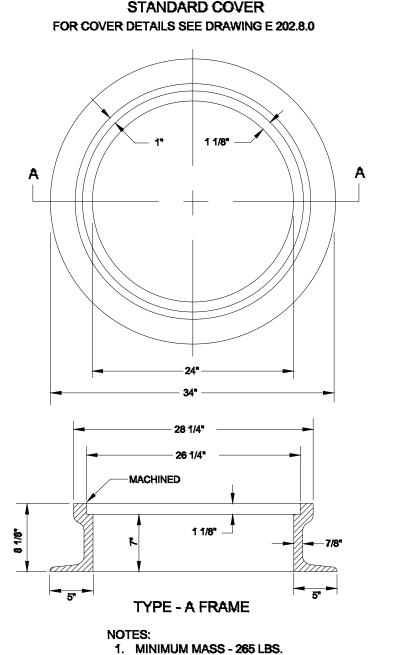


NEW FRAME AND COVER TO BE INSTALLED FOR CHANGE IN TYPE

2. MATERIAL - CAST IRON - SEE STANDARD SPECIFICATIONS


MANHOLE FRAME AND COVER

NOT TO SCALE

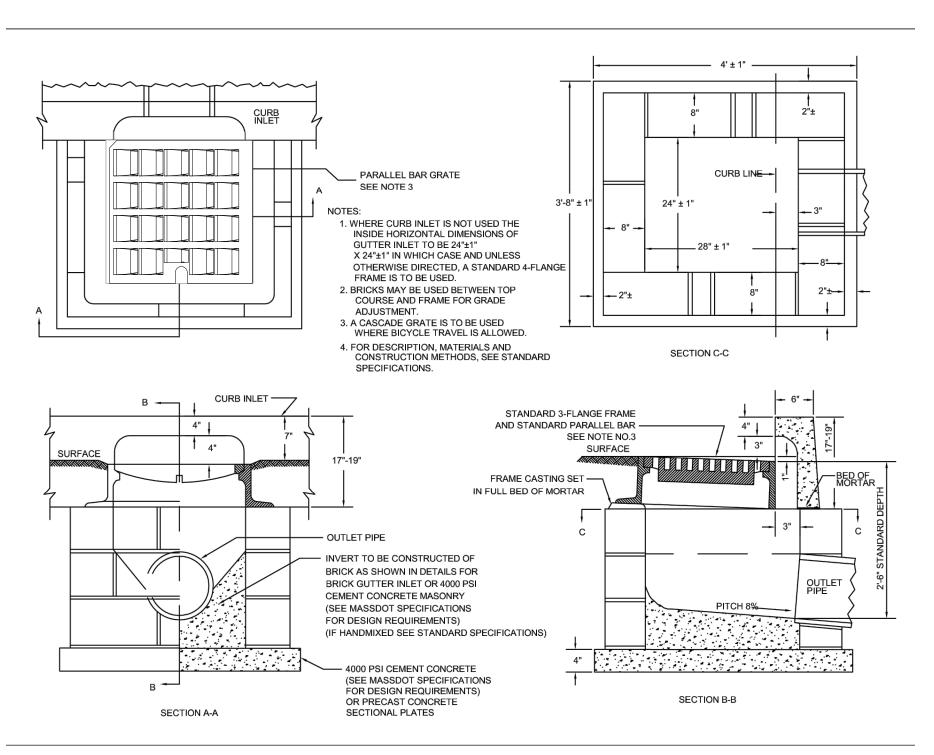

GUTTER INLET

NOT TO SCALE

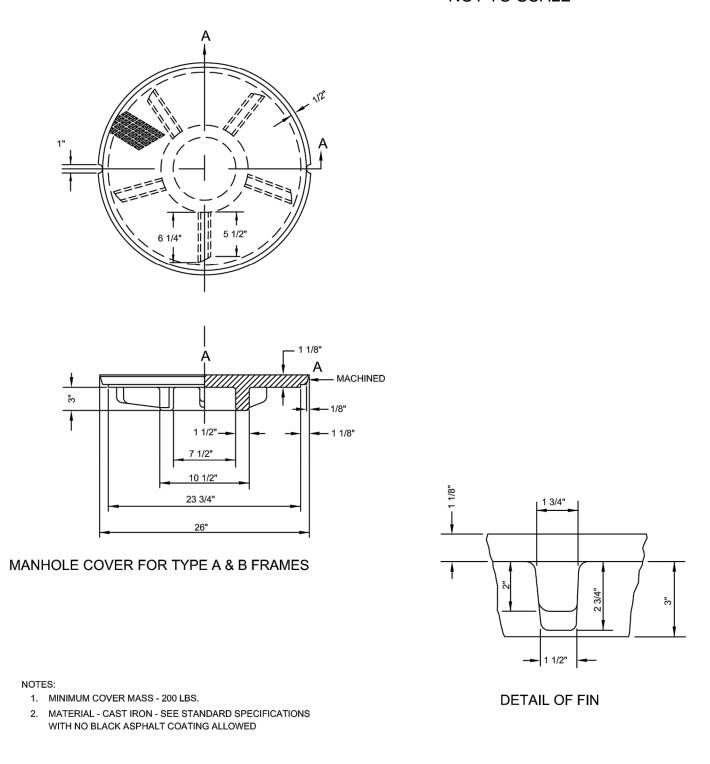

MANHOLE COVER DETAILS NOT TO SCALE

COVER SEE DRAWINGS E 202.6.0-E 202.8.0 BRICKS MAY BE USED FOR GRADE ADJUSTMENTS. FRAME TO BE SET IN FULL BED OF MORTAR SEE JOINT DETAILS MORTAR ALL JOINTS MIN. 0.12 SQ. IN. PER VERTICAL FOOT, PLACED ACCORDING TO AASHTO DESIGNATION MI99 1-#3 BAR AROUND OPENINGS FOR PIPES 18" DIAMETER AND OVER, 1" COVER FLOOR OF STRUCTURE TO BE HEADER\$ LAID FLAT DIAMETER PIPE BRICK CHIPS AND MORTAR OR 4000 PSI CEMENT CONCRETE (SEE MASSDOT SPECIFICATIONS FOR DESIGN REQUIREMENTS)
(IF CONCRETE IS HAND MIXED SEE LATEST STANDARD SPECIFICATIONS)
ALL CONCRETE TO BE AIR ENTRAINED PROVIDE "V" OPENINGS INVERTED ARCH WITH PIPE OPENINGS TO BE BRICKS LAID ON EDGE PRECAST IN RISER SECTION PRECAST UNIT PRECAST BASE 1" CLEAR CAST IN PLACE BASE JOINT DETAILS BASE DETAILS 1. FOR DESCRIPTIONS, MATERIALS AND CONSTRUCTION METHODS, SEE LATEST STANDARD SPECIFICATIONS.

TANDARD MANHOLE FRAME AND

PRECAST CONCRETE MANHOLE

NOT TO SCALE

PAVEMENT NOTES:

CEMENT CONCRETE SIDEWALK/WHEELCHAIR RAMP

SURFACE: 4" CEMENT CONCRETE

(4000 PSI, 3/4", 610, AIR-ENTRAINED)

BASE: 8" GRAVEL BORROW TYPE b

BRICK SIDEWALK

BASE:

SURFACE: BRICK PAVER (MATCH EXISTING)

3/4" SAND ASPHALT SETTING BED

SUB-BASE: 6" GRAVEL BORROW TYPE b

FULL DEPTH PAVEMENT CONSTRUCTION

1.5" SUPERPAVE SURFACE COURSE 9.5 (SSC-9.5) OVER

4" BITUMINOUS CONCRETE BINDER COURSE

5.50" SUPERPAVE INTERMEDIATE COURSE 19.0 (SIC-19.0)

(2 - 2.75" LIFTS) OVER

BASE: 12" GRAVEL BORROW TYPE b

FULL DEPTH PAVEMENT CONSTRUCTION (<4' WIDE) SURFACE:

1.5" SUPERPAVE SURFACE COURSE 9.5 (SSC-9.5) OVER 1.5" SUPERPAVE INTERMEDIATE COURSE 9.5 (SIC-9.5)

BASE: 6" CEMENT CONCRETE BASE COURSE OVER

(HIGH EARLY STRENGTH)

SUB-BASE 8" GRAVEL BORROW TYPE b (SEE GENERAL PAVEMENT NOTE 1)

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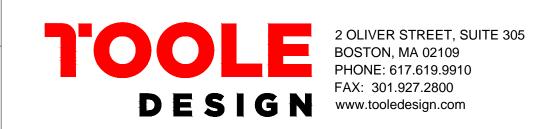
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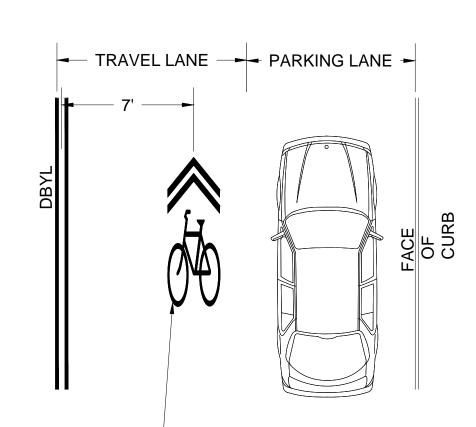


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CHURCH STREET AT WATERFIELD ROAD	
	CONSTRUCTION DETAILS

	60169
DATE	
	AUGUST 2021
DRAWING NO.	
	CD.02
SHEET NO.	
	15 OF 19




SHARED LANE MARKING
SEE MANUAL ON UNIFORM TRAFFIC CONTROL
DEVICES (MUTCD) FOR MORE DETAILS


SHARED LANE MARKING SYMBOL NOTES:

- 1. IN LOCATIONS WITH ON-STREET PARKING, SHARED LANE MARKING SYMBOLS SHALL BE PLACED SO THAT THEIR CENTERS ARE 7 FEET FROM THE ADJACENT DOUBLE YELLOW CENTER LINE UNLESS OTHERWISE NOTED ON THE PLANS.
- 2. IF LOCATED IN A TURN LANE, SHARED LANE MARKING SYMBOLS SHALL BE CENTERED IN THE LANE UNLESS OTHERWISE NOTED ON THE PLANS.
- 3. DO NOT PLACE SYMBOLS ON LANE LINES.
- 4. SEE PLANS FOR SYMBOL LOCATIONS.

SHARED LANE MARKING SYMBOL NOT TO SCALE

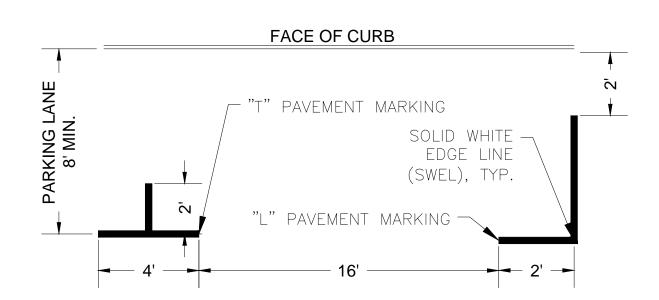


"T" PAVEMENT MARKING
NOT TO SCALE

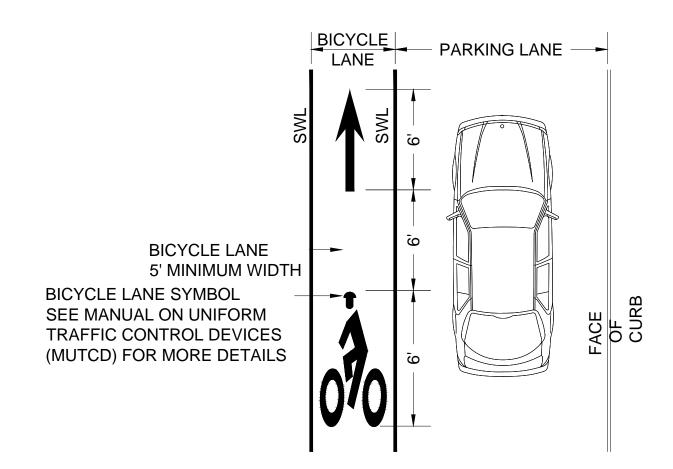


BICYCLE LANE STRIPING NOTES:


- 1. DO NOT PLACE SYMBOLS ON LANE LINES.
- 2. PLACE BICYCLE LANE SYMBOLS WITHIN CENTER OF BICYCLE LANE.
- 3. SEE PLAN SHEETS FOR SYMBOL LOCATIONS.
- 4. TRAVEL AND PARKING LANE WIDTHS ARE AS SHOWN ON THE DRAWINGS.
- 5. DO NOT PLACE SYMBOLS WITHIN DASHED LINES.

TYPICAL BIKE LANE STRIPING ADJACENT TO PARKING NOT TO SCALE

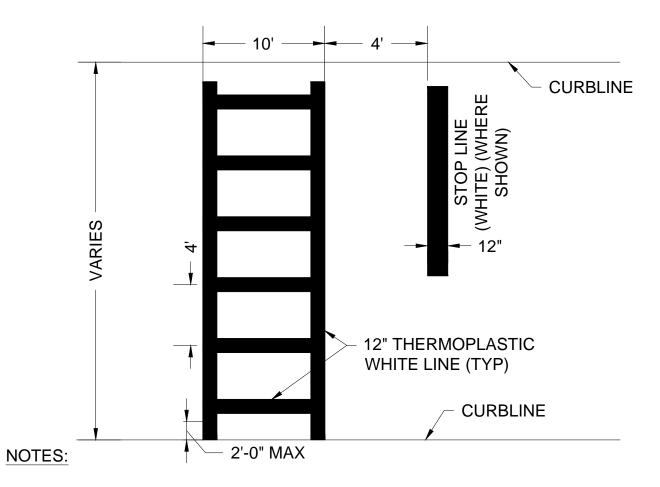

- 1. ALL 12" LINES SHALL BE APPLIED IN ONE APPLICATION, NO COMBINATION OF LINES (TWO 6" LINES) WILL BE ACCEPTED.
- 2. LAYOUT OF CROSSWALKS SHALL BE APPROVED BY THE ENGINEER PRIOR TO APPLICATION.
- 3. CROSSWALK BARS SHALL BE PLACED OUTSIDE THE VEHICULAR WHEEL PATH WHEREVER POSSIBLE.

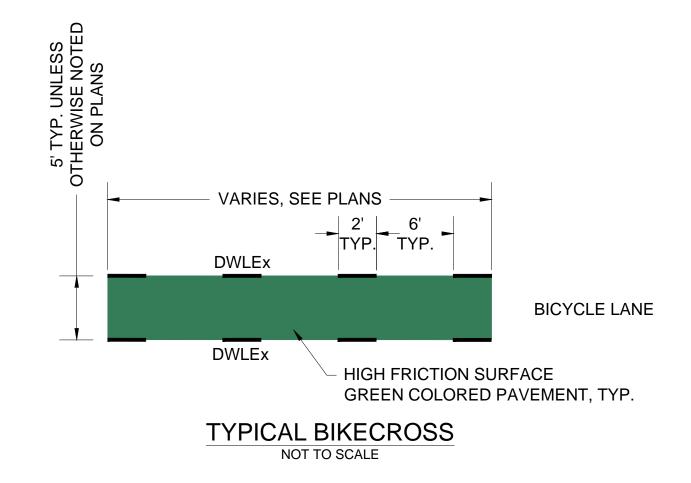

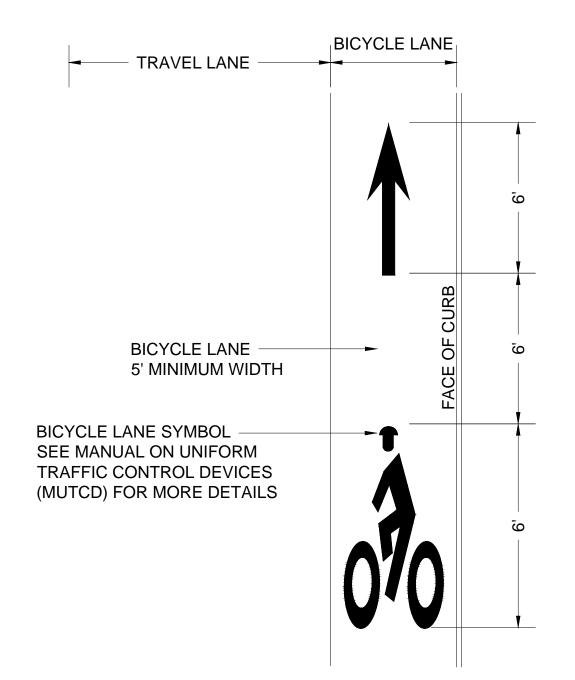

BICYCLE LANE STRIPING NOTES:

- 1. DO NOT PLACE SYMBOLS ON LANE LINES.
- 2. PLACE BICYCLE LANE SYMBOLS WITHIN CENTER OF BICYCLE LANE.
- 3. SEE PLAN SHEETS FOR SYMBOL LOCATIONS.
- 4. TRAVEL AND PARKING LANE WIDTHS ARE AS SHOWN ON THE DRAWINGS.
- 5. DO NOT PLACE SYMBOLS WITHIN DASHED LINES.

TYPICAL CROSSWALK PAVEMENT MARKING
NOT TO SCALE

TYPICAL BIKE LANE STRIPING ADJACENT TO CURB

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CHURCH STREET AT WATERFIELD ROAD PROJECT NO.


DATE

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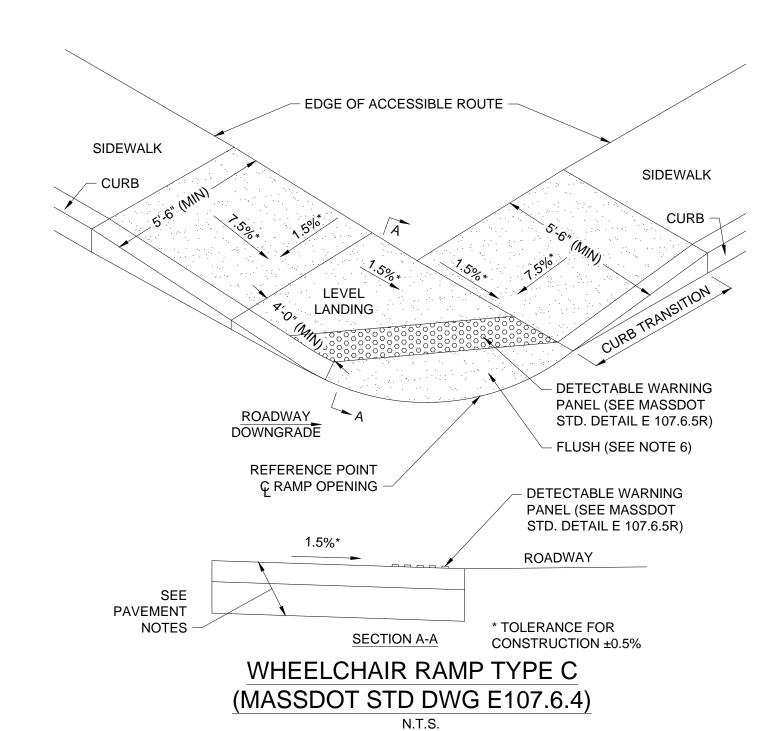
CONSTRUCTION DETAILS

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N.T.S. 5'-0" (MIN) __ LEVEL LANDING 4'-0" (MIN) – **GRASS** - CURB FLUSH (SEE NOTE 6) -REFERENCE POINT **DETECTIBLE WARNING PANEL** ROADWAY Ç RAMP OPENING (SEE MASSDOT STD. DETAIL E 107.6.5) DOWNGRADE PLAIN CEMENT CONCRETE - DETECTABLE WARNING PANEL (SEE MASSDOT SIDEWALK STD. DETAIL E 107.6.5) 7.5%* ROADWAY * TOLERANCE FOR PAVEMENT NOTES -CONSTRUCTION ±0.5% SECTION A-A WHEELCHAIR RAMP TYPE B



WHEELCHAIR RAMP NOTES:

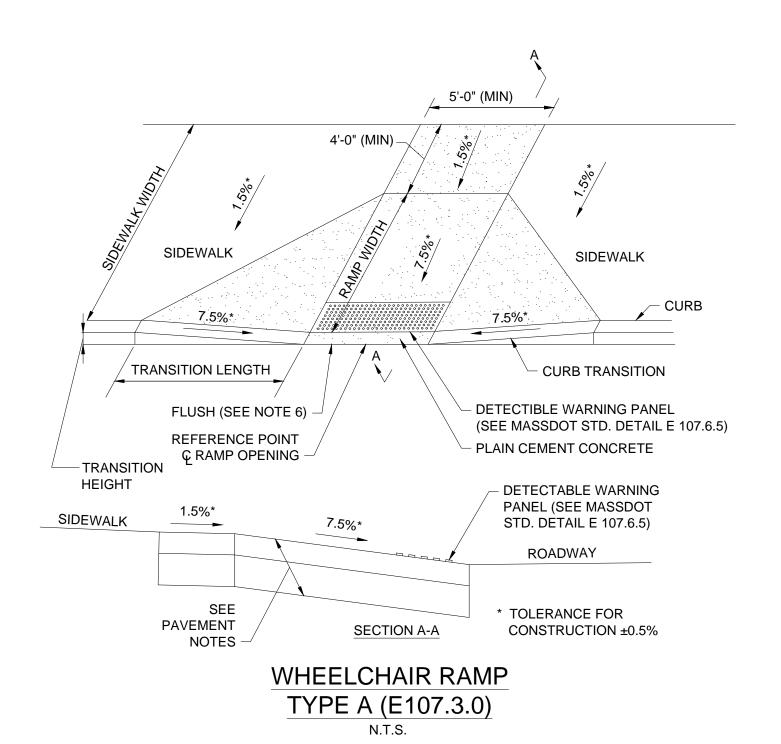
- 1. MAXIMUM ALLOWABLE SLOPE OF ACCESSIBLE ROUTE EXCLUDING CURB RAMPS SHALL BE DESIGNED TO 4.5% ±0.5% (7.5% ±0.5% FOR CURB RAMPS)
- 2. A MINIMUM OF 3'-3" CLEAR SHALL BE MAINTAINED AT ANY PERMANENT OBSTACLE IN ACCESSIBLE ROUTE (I.E., HYDRANTS, UTILITY POLES, TREE WELLS, SIGNS, ETC.).
- 3. CURB TREATMENT VARIES, SEE PLANS FOR CURB TYPE.
- 4. RAMP, CURB AND ADJACENT PAVEMENTS SHALL BE GRADED TO PREVENT PONDING.
- 5. WHERE ACCESSIBLE ROUTES ARE LESS THAN 5' IN WIDTH (EXCLUDING CURBING) A 5'x5' PASSING AREA SHALL BE PROVIDED AT INTERVALS NOT TO EXCEED 200 FT.
- 6. ELIMINATE CURBING AT RAMP WHERE IT ABUTS ROADWAY.
- 7. DETECTABLE WARNING PANELS ARE REQUIRED ON ALL OF THE PROPOSED WHEELCHAIR RAMPS AND ARE TO BE INSTALLED IN ACCORDANCE WITH CONSTRUCTION STANDARD E 107.6.5 (OCTOBER 2017). CONTRACTOR SHALL PROVIDE 6" BETWEEN DETECTABLE WARNING PANEL AND EDGE OF CONCRETE WHERE IT ABUTS LOAM & SEED.
- 8. WHEELCHAIR RAMP SLOPES AND CROSS SLOPES SHALL HAVE A CONSTRUCTION TOLERANCE OF ±0.5%.

ROADWAY PROFILE GRADE	HIGH SIDE TRANSITION LENGTH*
=0%	6'-6"
>0% TO 1%	7'-8"
>1% TO 2%	9'-0"
>2% TO 3%	11'-0"
>3% TO 4%	14'-0"
>4% TO 5%	15'-0" MAX

CURB TRANSITION LENGTH FOR WHEELCHAIR RAMPS

*NOTE: BASED ON A DESIGN SLOPE OF 7.5% AND REVEAL OF 6".

WCR DATA TABLE												
			DRIVEWAY REFERENCE		OPENING ROA	ROADWAY	RAMP	SIDEWALK	TRANSITION LEFT		TRANSITION RIGHT	
NUMBER	TYPE	STREET NAME	STATION	OFFSET	WIDTH (FT)	GUTTER SLOPE	LENGTH (FT)	WIDTH (FT)	LENGTH (FT)	REVEAL (IN)	LENGTH (FT)	REVEAL (IN)
1	А	CHURCH STREET	11+12.23	15.31' LT	5.0	0.2%	7.0	14.8	8	7	8	7
2	-	CHURCH STREET	11+12.68	18.43' RT	7.0	1.5%	7.4	11.7	-	-	-	-
3	-	WATERFIELD ROAD	10+84.56	13.54' LT	6.5	1.5%	6.4	VARIES	-	-	-	-
4	В	WATERFIELD ROAD	10+84.89	13.66' RT	8.0	1.5%	2.2	VARIES	-	-	-	-
5	С	CHURCH STREET AT DIX STREET	WCR-5 TO BE FIELD ENGINEERED									
6	С	CHURCH STREET AT DIX STREET	WCR-6 TO BE FIELD ENGINEERED									

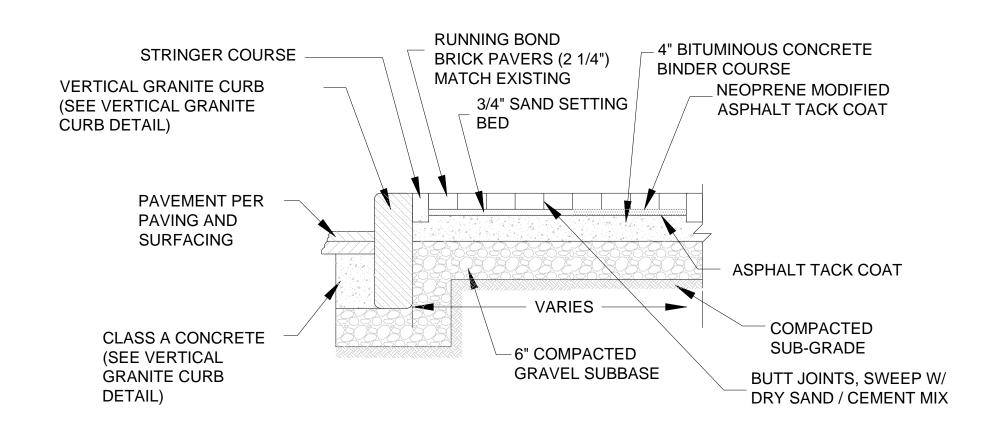

BRICK SIDEWALK

NOT TO SCALE

NOTES:

SIDEWALKS SHALL MATCH WIDTH AND SLOPE OF EXISTING SIDEWALKS UNLESS OTHERWISE NOTED.
 BITUMINOUS CONCRETE BINDER COURSE SHALL BE 6" DEPTH (IN TWO 3" COURSES) AT DRIVEWAYS. REFER TO PROJECT DRAWINGS OR ENGINEER'S INSTRUCTIONS FOR LOCATIONS

FINAL DESIGN SUBMISSION

17 OF 19

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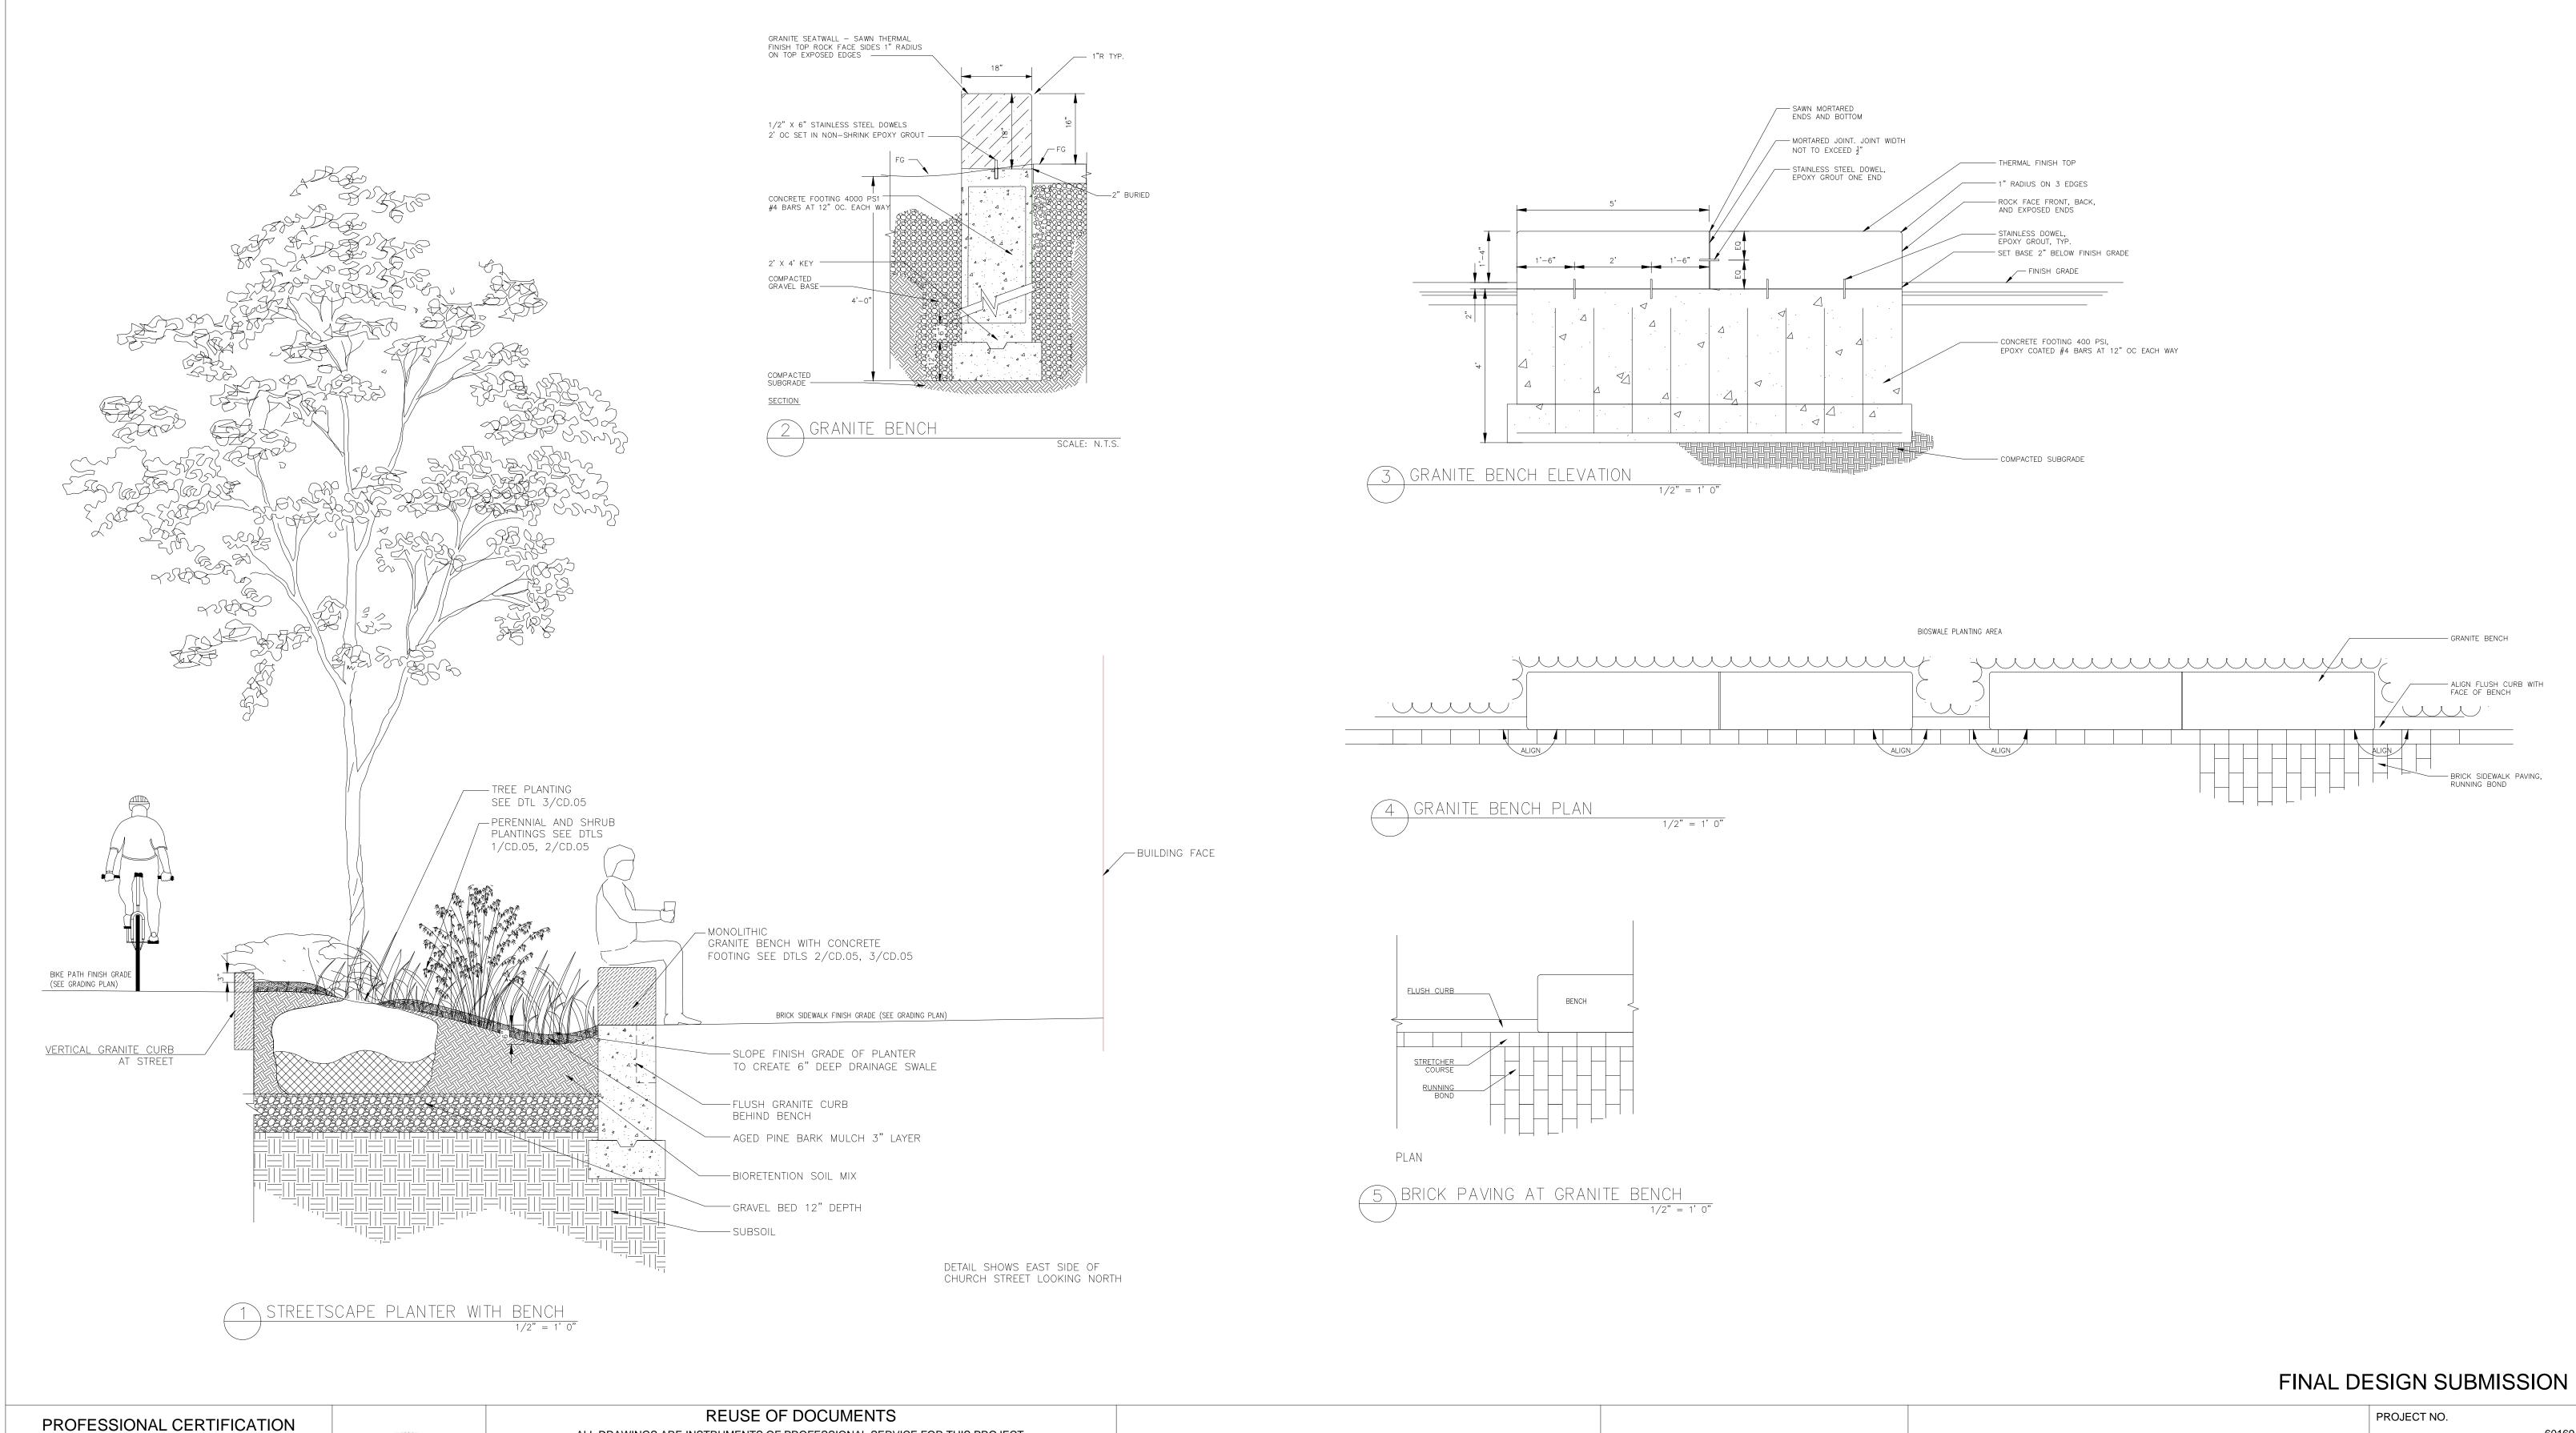


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CHURCH STREET AT WATERFIELD ROAD	
	CONSTRUCT

	PROJECT NO.
	60169
	DATE
	AUGUST 2021
CONSTRUCTION DETAILS	DRAWING NO.
CONSTRUCTION DETAILS	CD.04
	SHEET NO.



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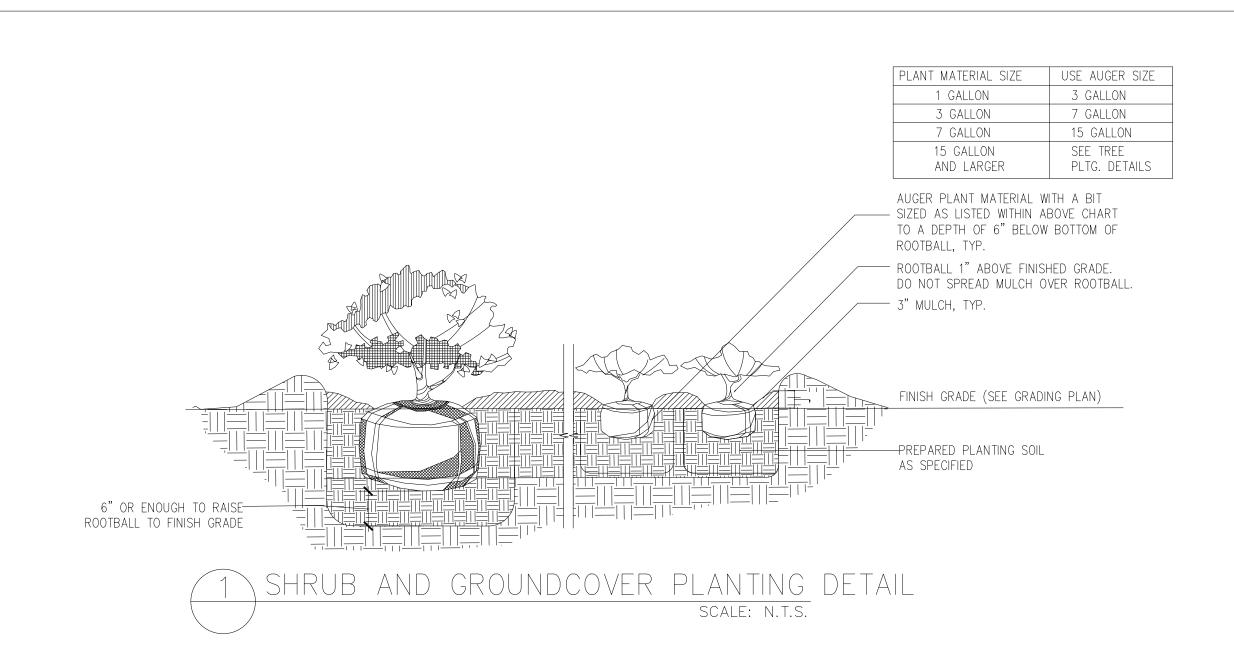
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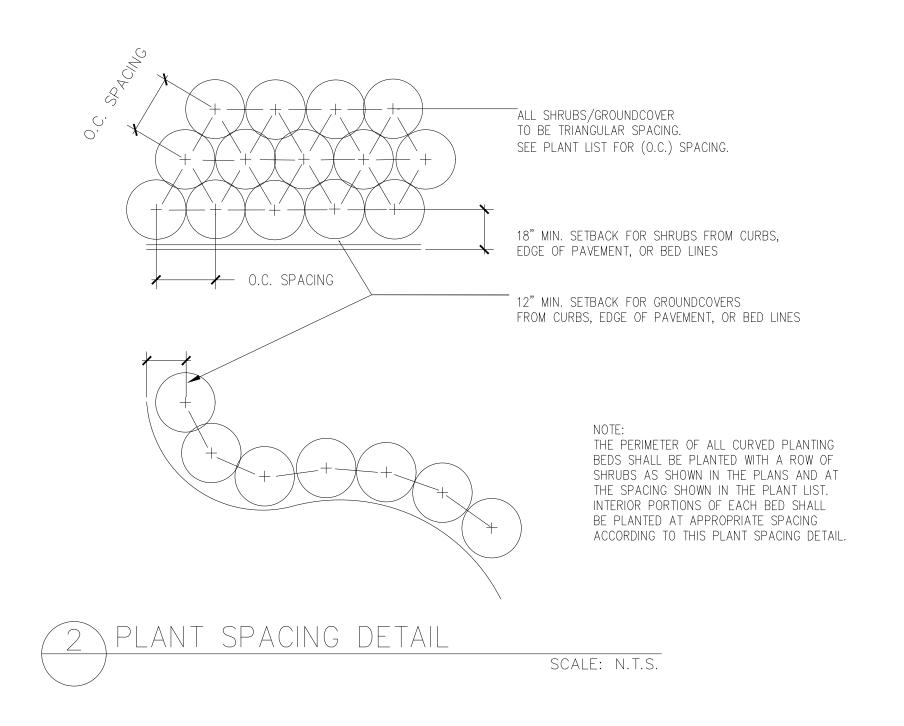



CHURCH STREET AT WATERFIELD ROAD

LANDSCAPE DETAILS


60169 DATE AUGUST 2021 DRAWING NO. CD.05 SHEET NO. 18 OF 19






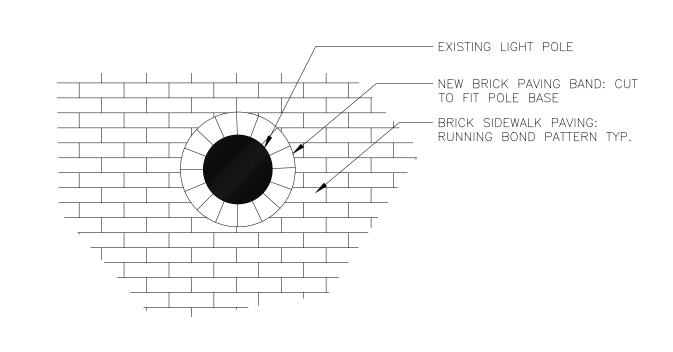

BRICK PAVING AT EXISTING LIGHT POLE

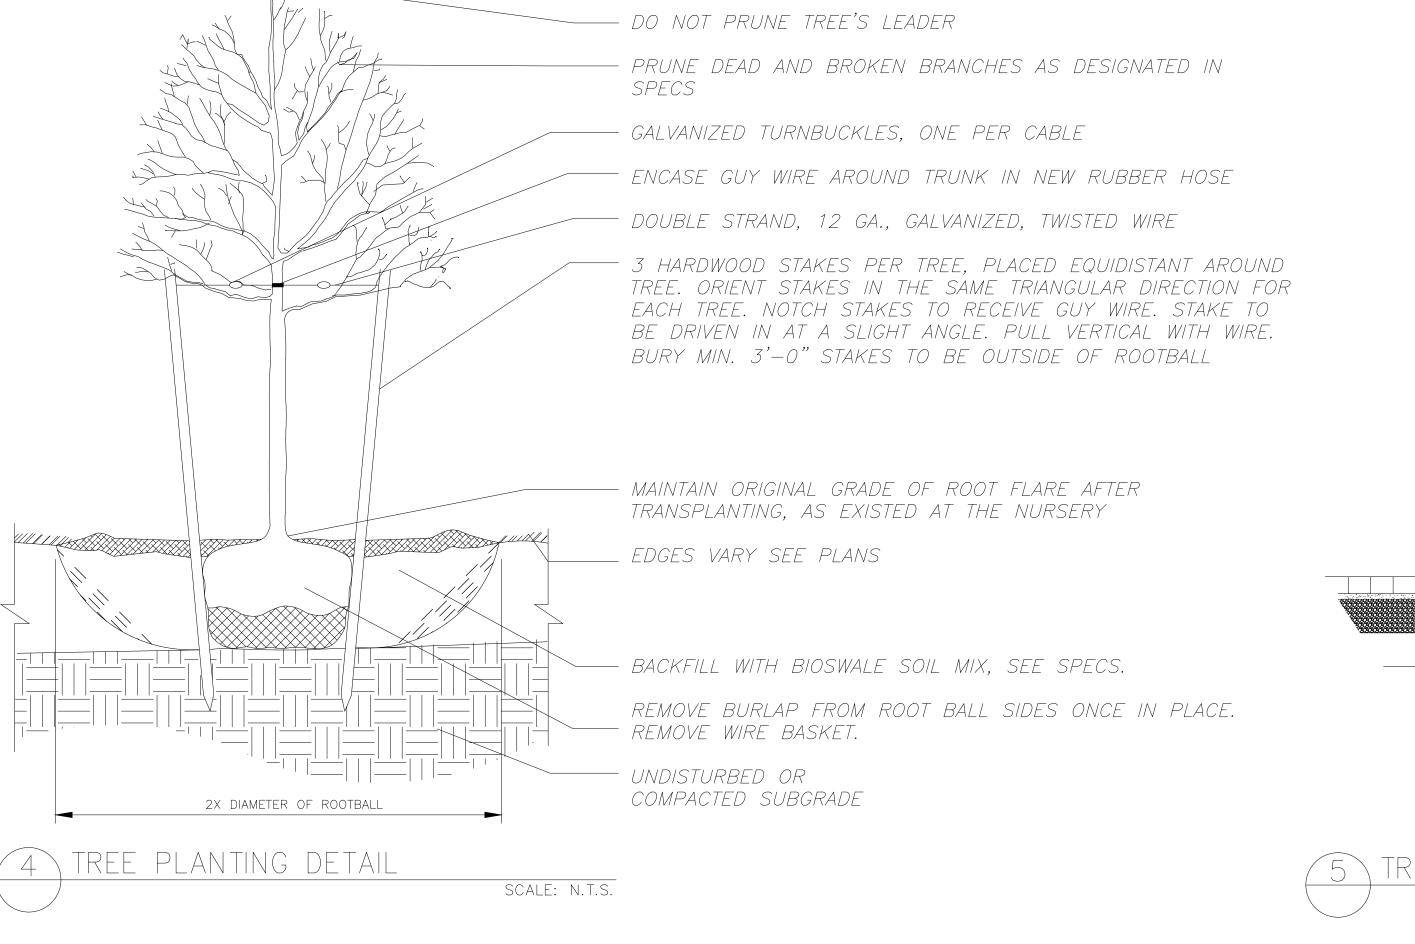

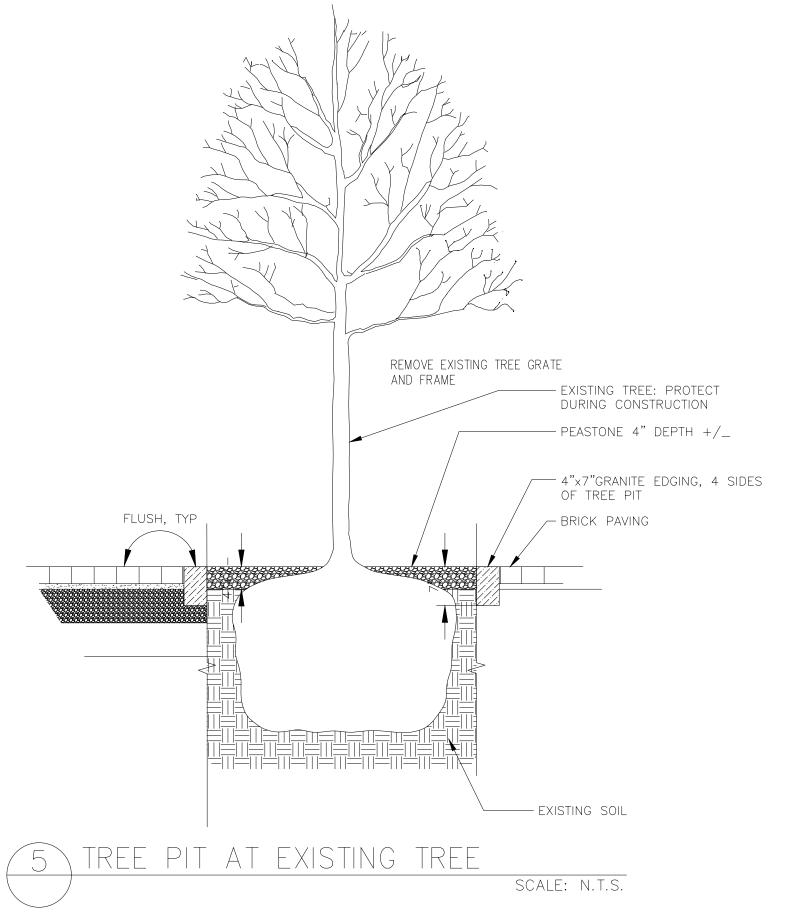

FINAL DESIGN SUBMISSION

PROFESSIONAL	CERTIFICATION
-	

I HEREBY CERTIFY THAT THESE PLANS WERE PREPARED OR APPROVED BY ME, AND THAT I AM A DULY LICENSED PROFESSIONAL ENGINEER UNDER THE LAWS OF THE COMMONWEALTH OF MASSACHUSETTS, LICENSE NO. 49208, EXPIRATION DATE: 6/30/2022.



REUSE OF DOCUMENTS ALL DRAWINGS ARE INSTRUMENTS OF PROFESSIONAL SERVICE FOR THIS PROJECT. REUSE OR ALTERATION IS AT THE USER'S SOLE RISK. KMF CBK CHK MAB

REVISION

ELG NO. DATE

DESIGN www.tooledesign.com BY APVD

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CHURCH STREET AT WATERFIELD ROAD

LANDSCAPE DETAILS

PROJECT NO. 60169 DATE AUGUST 2021 DRAWING NO. CD.06 SHEET NO.